870 Autumn Crest Dr. Wenatchee. WA CASCADE

Architecture & Design

1405 POPLAR AVE. WENATCHEE, WASHINGTON p: 509-436-8227 e: kirsten@cascadearchitectureanddesign.cor

WITH GOVERNING CODES AND ORDINANCES. TH CONTRACTOR SHALL REVIEW AND UNDERSTAND ARCHITECT IMMEDIATELY OF ANY DISCREPANCIES IN THE DRAWINGS, FIELD CONDITIONS OR DIMENSIONS.

PROJECT NUMBER:







SCOPE OF WORK

NEW CONSTRUCTION

NEW CONSTRUCTION OF 4523 SQFT SINGLE FAMILY HOME W/ 3 CAR GARAGE & WALKOUT BASEMENT

PROJECT INFO

LEGAL DESCRIPTION	BIRCH RUN PHASE 5 LOT 9 0.6000 ACRES				
BUILDING SIGNAGE	PROMINENTLY DISPLAYED IN CONTRASTING COLORS, PLAINLY VISIBLE FROM STREET				
BUILDING AREA	TOTAL COVERED FOOTPRINT: 3250 SQFT MAIN LEVEL CONDITIONED: 2347 SQFT LOWER LEVEL CONDITIONED: 2355 SQFT GARAGE: 903 SQFT				
PARCEL NUMBER	232017485090				
ZONING	RS				
BUILDING TYPE	SINGLE FAMILY DWELLING				
CLIMATE ZONE	5				
SNOW LOAD	40#				
WIND SPEED	85 MPH				
SETBACK MINIMUMS	FRONT: 20' SIDE: 5' REAR: 20'				
CONSTRUCTION TYPE	5B NON RATED				
OCCUPANCY	R-3				
LOT SIZE	0.6000 ACRES				
ENERGY COMPLIANCE	FENESTRATION U - 0.28, SHGC - 0.50 DBL PANE, LOW-E CEILING R-49 WD FRAME WALL FLOOR SLAB R-10/5 2' PER. 6 MIL VAPOR BARRIER U - 0.28, SHGC - 0.50 DBL PANE, LOW-E R-49 W-49 R-49 R-21 FLOOR R-30 SLAB R-10/5 2' PER. 6 MIL VAPOR BARRIER 24" FROST DEPTH				

APPLICABLE CODES:

2018 INTERNATIONAL RESIDENTIAL CODE (IRC)

2018 INTERNATIONAL MECHANICAL CODE (IMC) 2017 INTERNATIONAL FIRE CODE (IFC)

2018 WASHINGTON STATE ENERGY CODE (WSEC)

2018 INTERNATIONAL FUEL GAS CODE (IFGC)

PROJECT TEAM

OWNER JAKE GANN

866 AUTUMN CREST DR. WENATCHEE, WA 98801 P: 509.630.5262

CONTRACTOR JAKE GANN

866 AUTUMN CREST DR. WENATCHEE, WA 98801 P: 509.630.5262

ARCHITECT

CASCADE ARCHITECTURE AND DESIGN KIRSTEN EHRHARDT

1405 POPLAR AVE

WENATCHEE, WA 98801

P: 509.436.8227

E: kirsten@cascadearchitectureanddesign.com

STRUCTURAL ENGINEER

JON CONNER ENGINEERING JON CONNER 715 99TH AVE. SE

BUILDING

LAKE STEVENS, WA 98258 P: 206.914.9536

E:JConner.Engineering@outlook.com

SHEET INDEX 004-ARCHITECTURAL

A0.1 ASSEMBLIES A1.0 SITE PLAN

A1.1 LOWER LEVEL PLAN

A1.2 MAIN LEVEL PLAN

A1.3 ROOF PLAN

A2.0 ELEVATIONS

A2.1 ELEVATIONS A3.0 BUILDING SECTIONS

A3.1 BUILDING SECTIONS

005-STRUCTURAL

\$1.0 FOUNDATION PLAN

S1.1 MAIN LEVEL FRAMING PLAN

S1.2 ROOF FRAMING PLAN

S5.0 DETAILS

S5.1 DETAILS

SYMBOLS

BUILDING ELEVATION

INTERIOR

ELEVATION

ELEVATION

KEYNOTE

WINDOW

WALL TAG

CENTERLINE

DOOR NUMBER 101A

A

Submission 1


ISSUED/REVISION SCHEDULE DESCRIPTION AUTHOR DATE


> PERMIT 10.03.2022

COVER SHEET


SHEET NAME

ASSEMBLIES

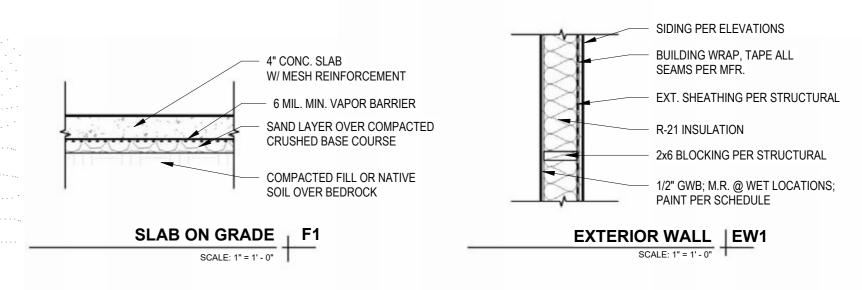


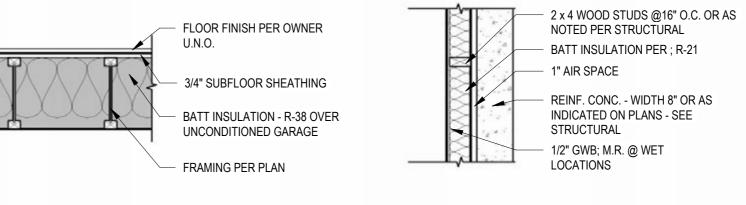

WOOD FRAMED FLOOR | F2 INTERIOR FURRING WALL | EW2 SCALE: 1" = 1' - 0" SCALE: 1" = 1' - 0"

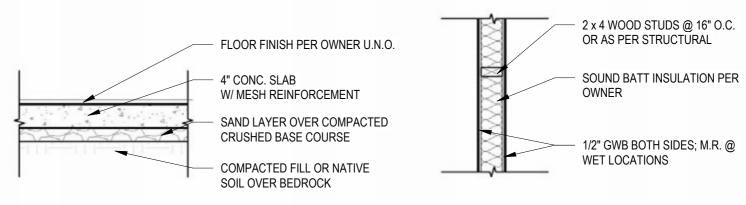

INTERIOR WALL (SOUND BATT) | IW1 INTERIOR S.O.G. F3 SCALE: 1" = 1' - 0"

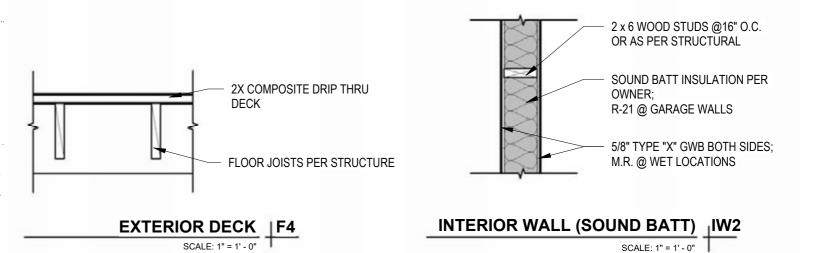

N CREST AUTUMN

880 CREST WA 98 870 AUTUMN (WENATCHEE,

Architecture & Design

1405 POPLAR AVE.

WENATCHEE, WASHINGTON

p: 509-436-8227

e: kirsten@cascadearchitectureanddesign.com

ARCHITECT

STATE OF WASHINGTON

THESE DOCUMENTS ARE PROVIDED BY CASCADE

ARCHITECTURE & DESIGN, FOR THE DESIGN INTENT

OF THIS SPECIFIC PROJECT AND ONLY THIS

PROJECT. THE CONTRACTOR SHALL BE RESPONSIBLE FOR ALL CONSTRUCTION

COORDINATION, METHODS AND MATERIALS

REQUIRED FOR THE SUCCESSFUL COMPLETION OF

THE PROJECT. THIS INCLUDES BUT IS NOT LIMITED TO

THE QUALITY OF WORKMANSHIP AND MATERIALS · REQUIRED FOR EXECUTION OF THESE DOCUMENTS

. AND WORK OR MATERIALS SUPPLIED BY ANY SUBCONTRACTORS. ALL WORK SHALL COMPLY WITH GOVERNING CODES AND ORDINANCES. THE CONTRACTOR SHALL REVIEW AND UNDERSTAND

ALL DOCUMENTS AND SHALL NOTIFY THE ARCHITECT IMMEDIATELY OF ANY DISCREPANCIES

IN THE DRAWINGS, FIELD CONDITIONS OR DIMENSIONS.

PROJECT NUMBER:

22.017

KIRSTEN EHRHARDT 10/10/2022


ISSUED/REVISION SCHEDULE DESCRIPTION AUTHOR DATE

> PERMIT 10.03.2022

SHEET NAME

ASSEMBLIES



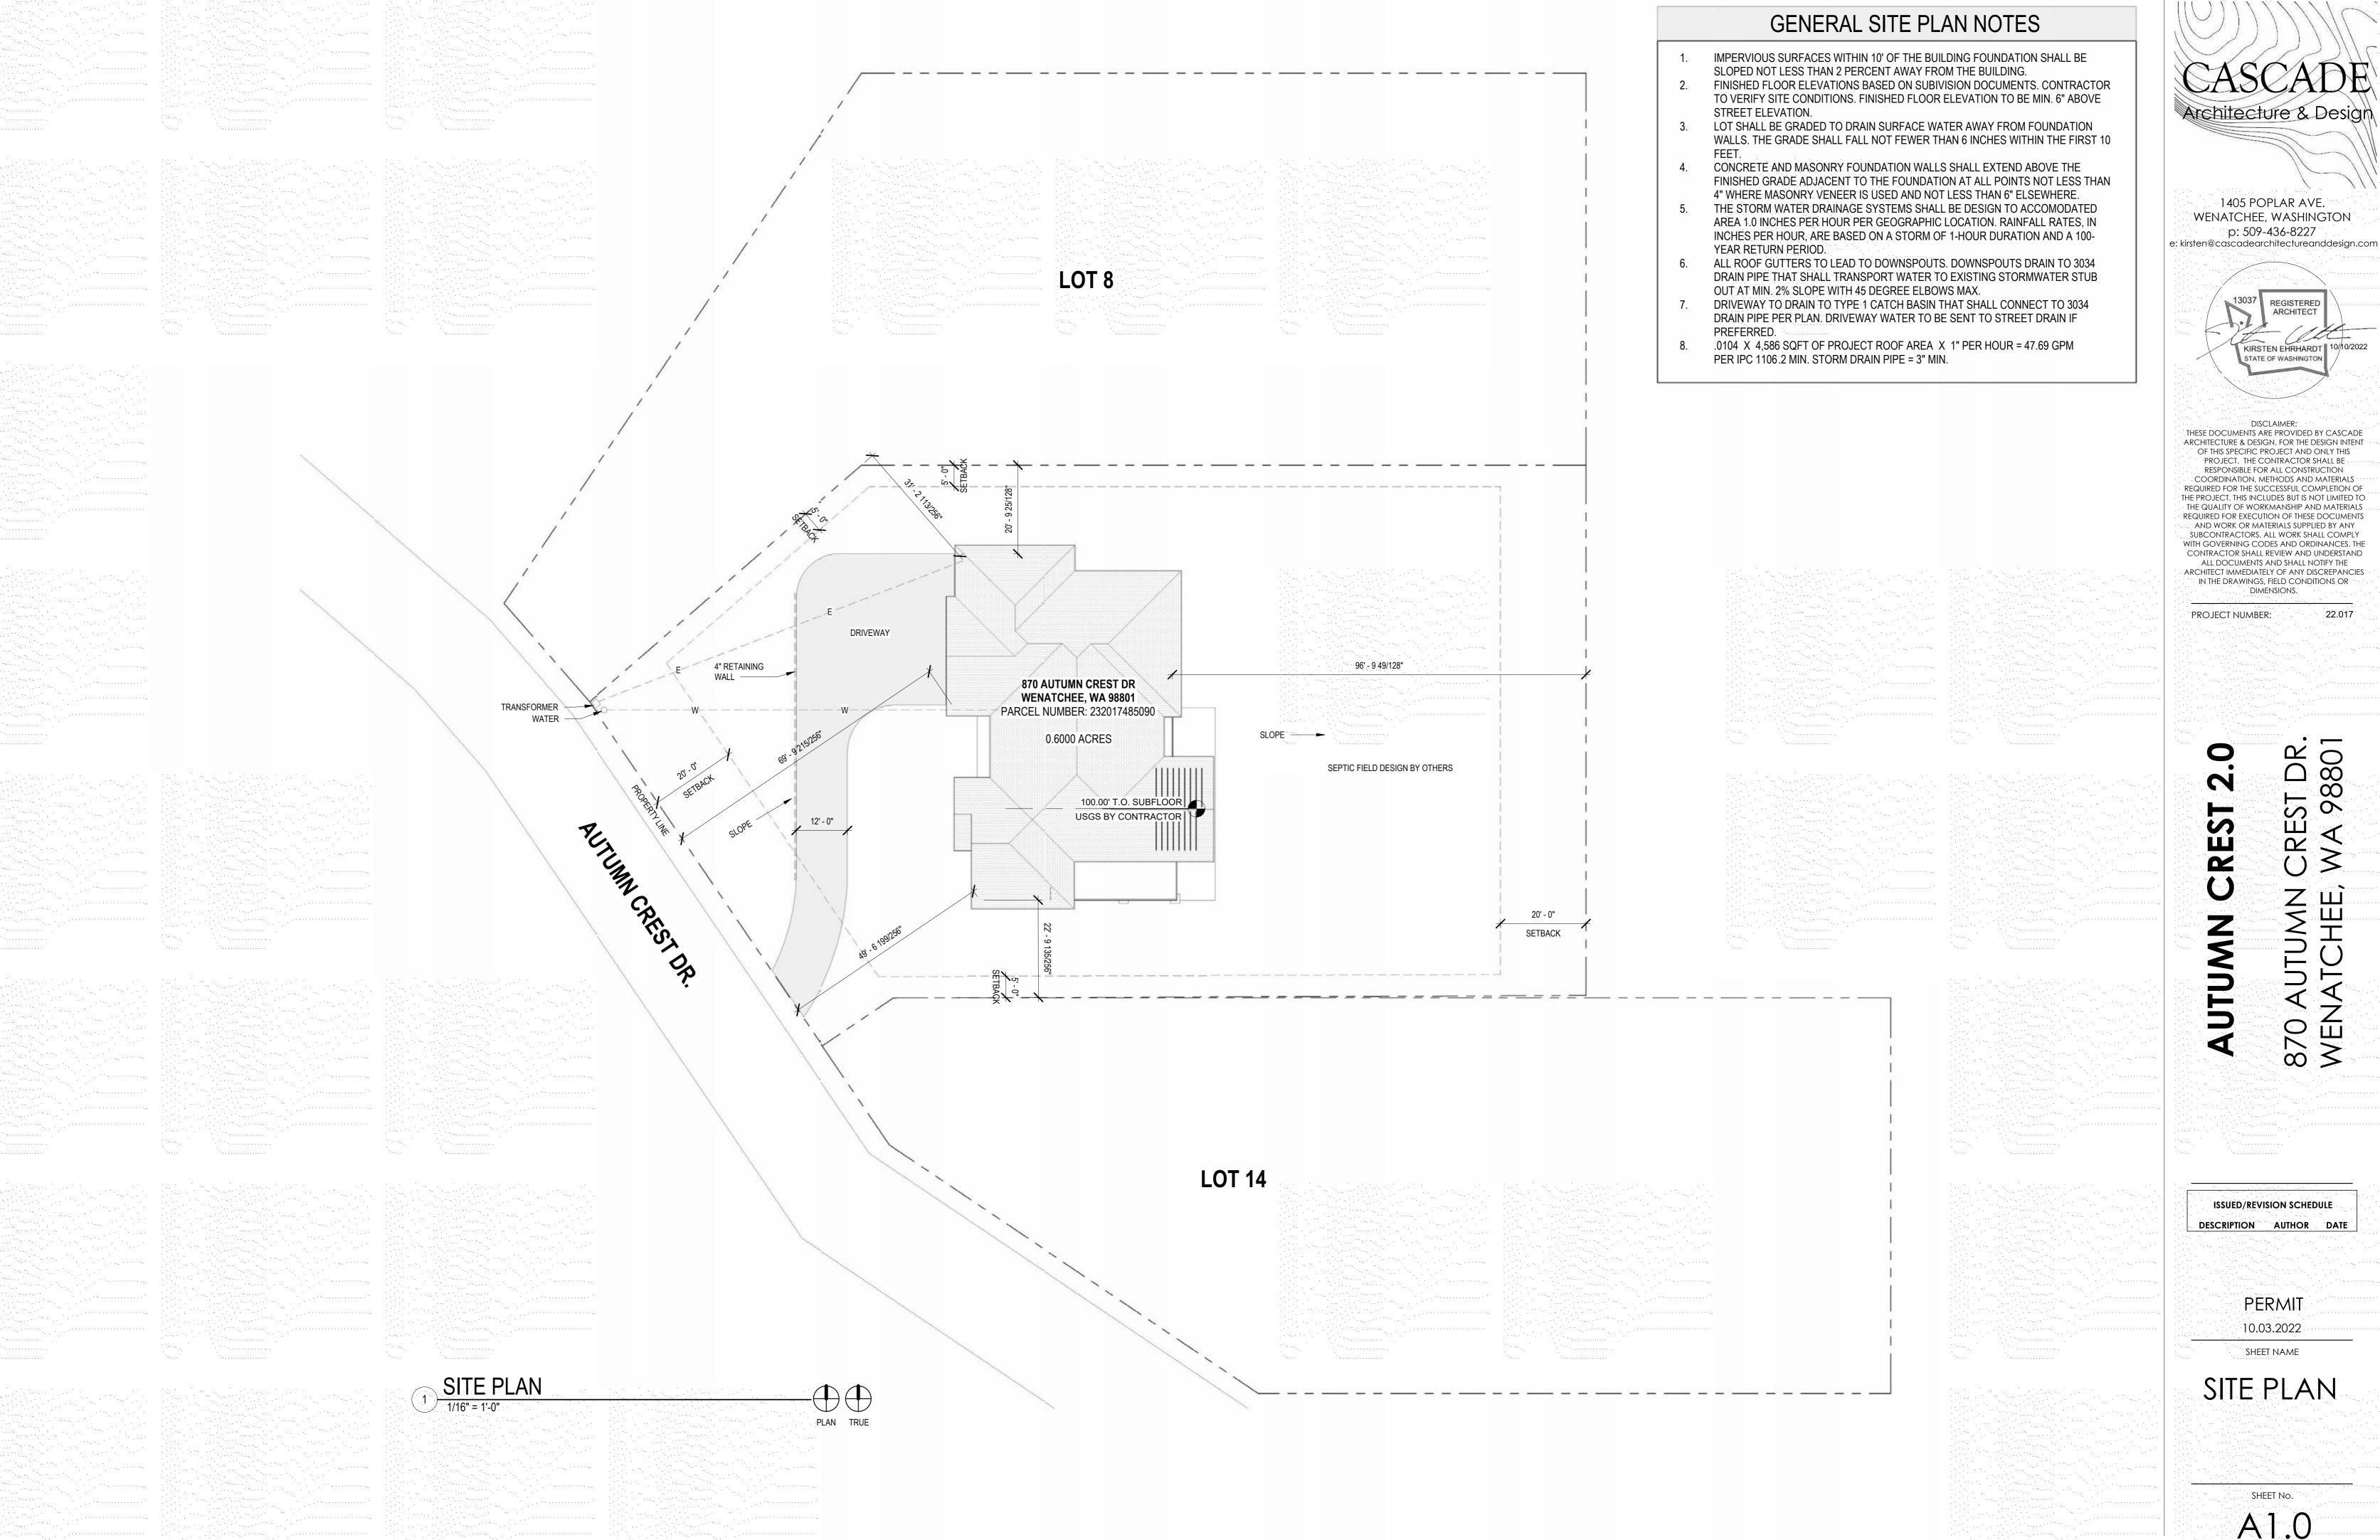

ARCHITECT KIRSTEN EHRHARDT | 10/10/2022 STATE OF WASHINGTON

1405 POPLAR AVE.

WENATCHEE, WASHINGTON

p: 509-436-8227

THESE DOCUMENTS ARE PROVIDED BY CASCADE ARCHITECTURE & DESIGN, FOR THE DESIGN INTENT RESPONSIBLE FOR ALL CONSTRUCTION COORDINATION, METHODS AND MATERIALS REQUIRED FOR EXECUTION OF THESE DOCUMENTS WITH GOVERNING CODES AND ORDINANCES. THE CONTRACTOR SHALL REVIEW AND UNDERSTAND ALL DOCUMENTS AND SHALL NOTIFY THE ARCHITECT IMMEDIATELY OF ANY DISCREPANCIES

PROJECT NUMBER:


in the drawings, field conditions or DIMENSIONS.

REST

PERMIT

10.03.2022 SHEET NAME

SITE PLAN

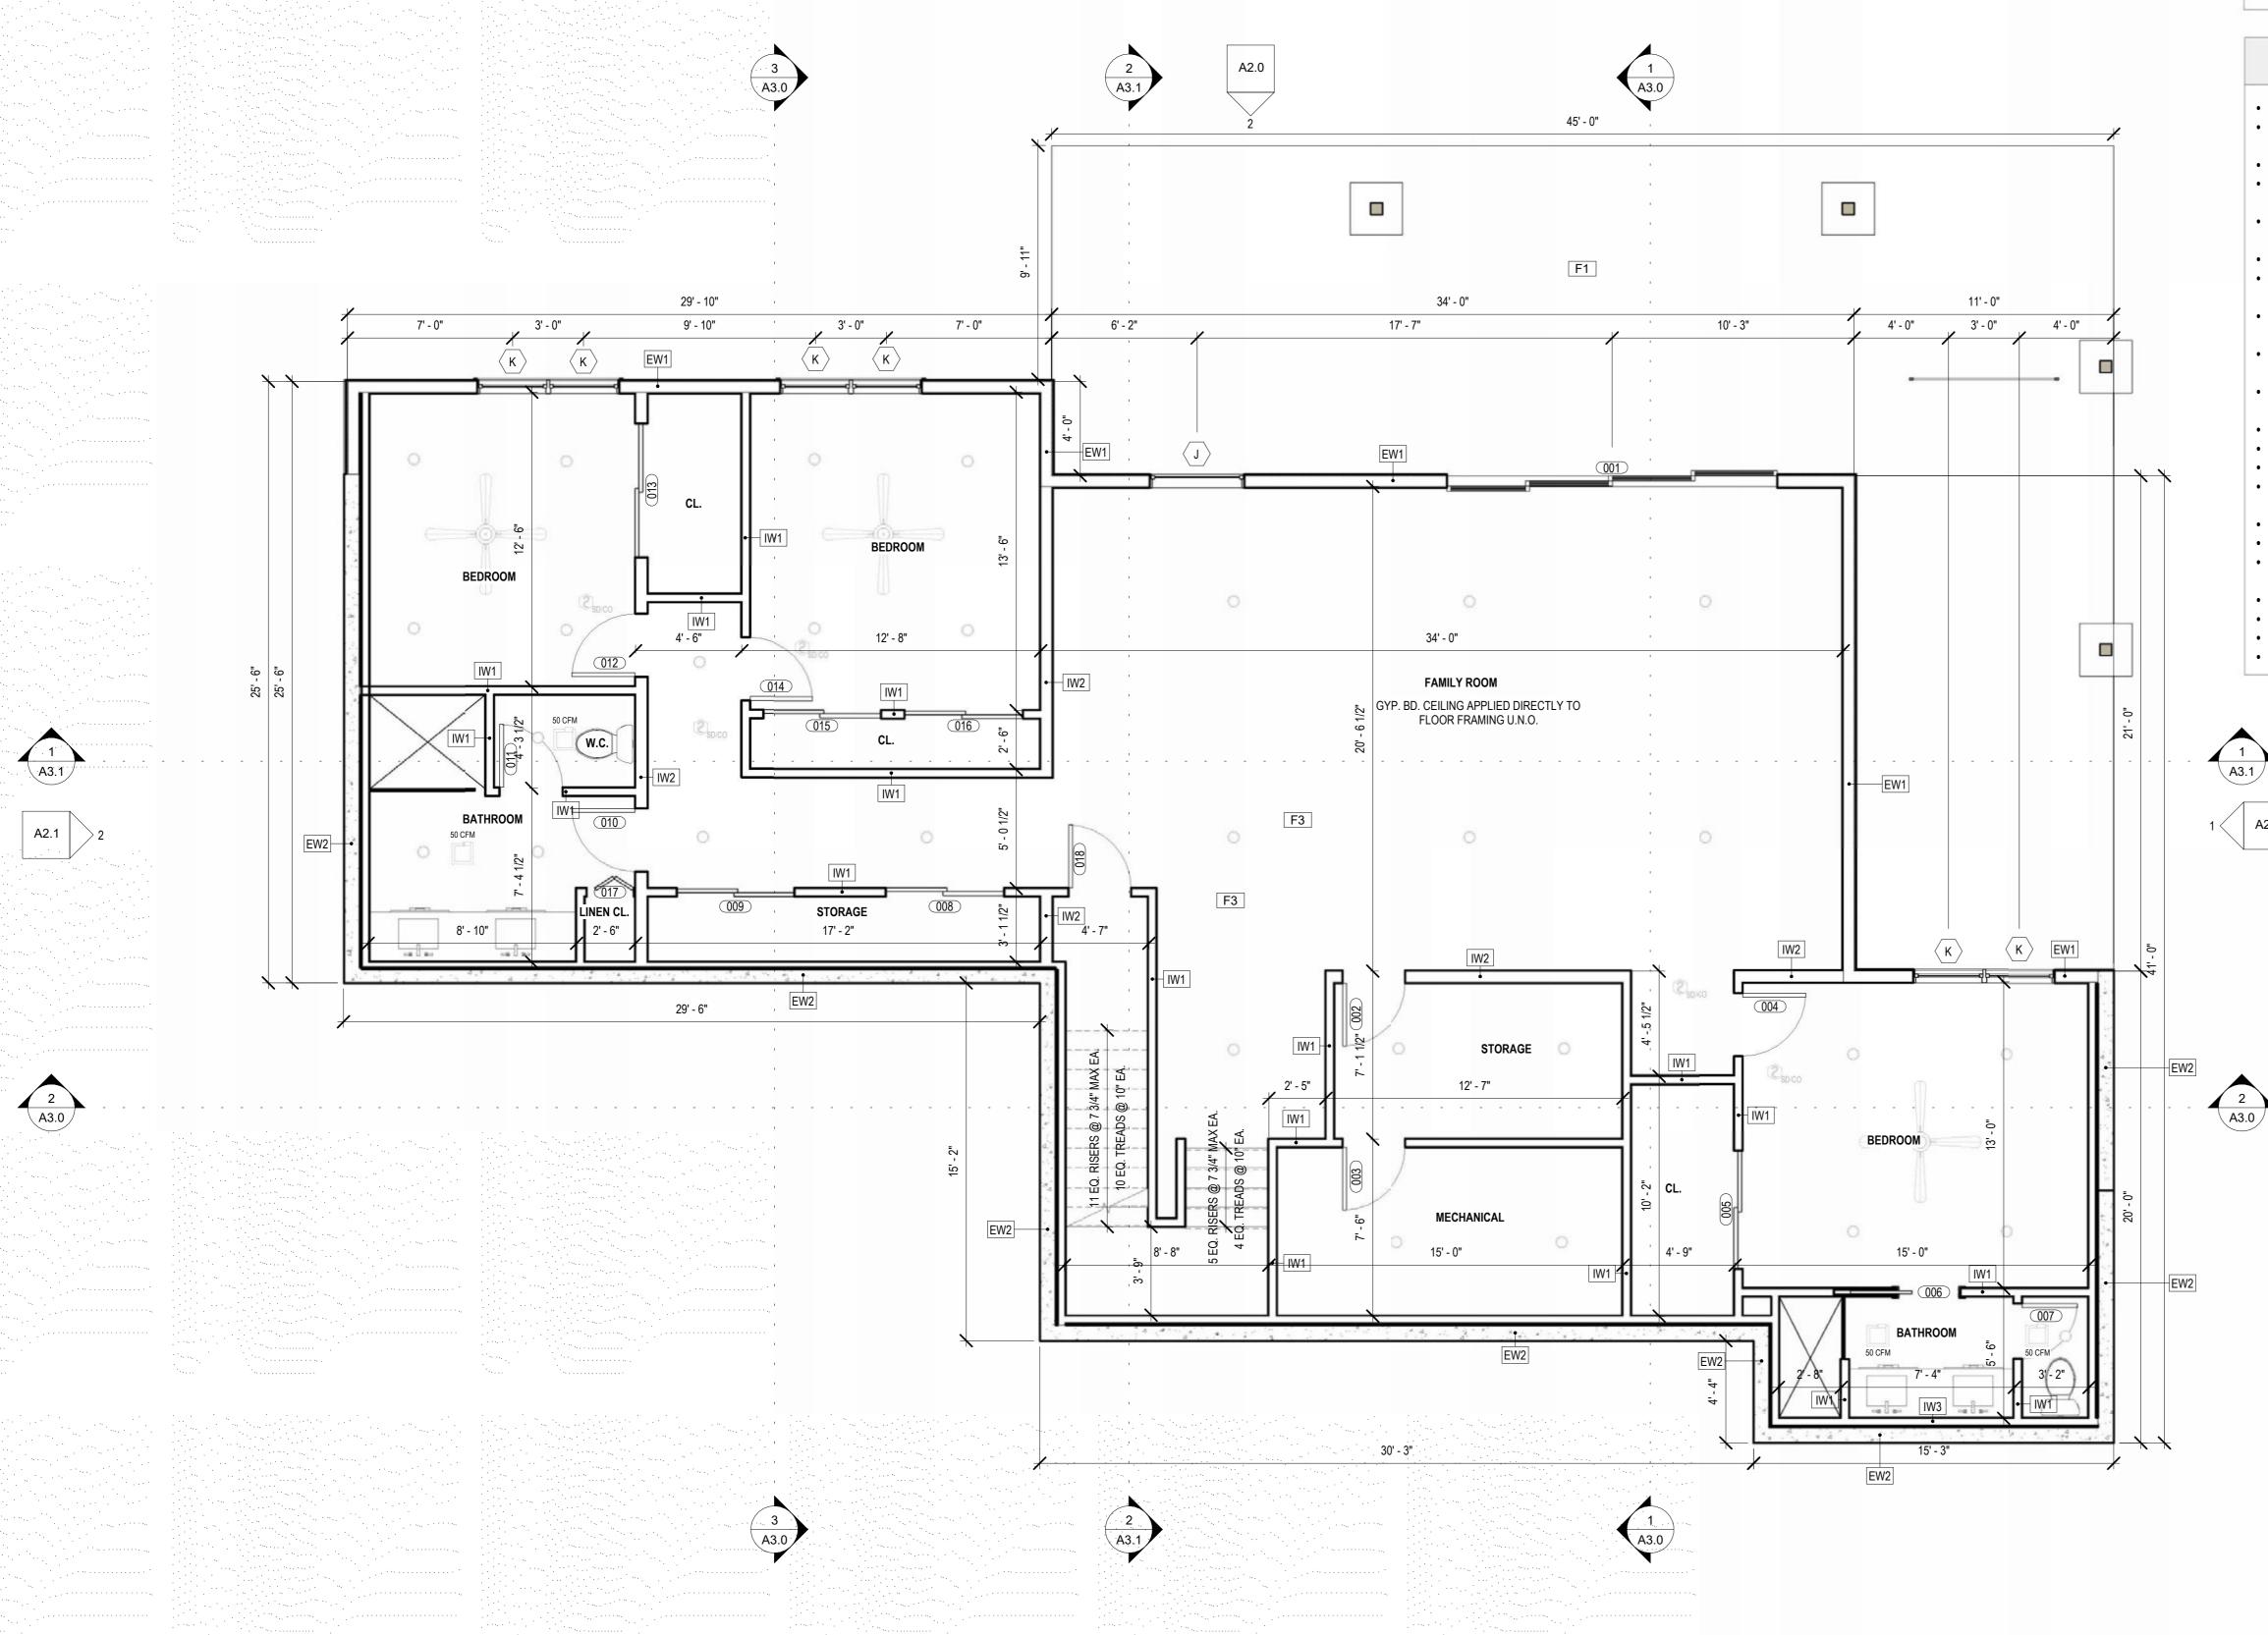

LOWER LEVEL PLAN

GENERAL PLAN NOTES


- ALL EXTERIOR DIMENSIONS ARE TAKEN FROM FACE OF CONC. FOUNDATION WALL /
- ALL INTERIOR DIMENSIONS ARE TAKEN FROM F.O.S. TO C.L. OF PARTITION U.N.O.
- DIMENSIONS INDICATING 'CLEAR' OR F.O.W. ARE TAKEN FROM FINISH
- COMBINATION SMOKE/CARBON MONOXIDE DETECTORS TO BE ISTALLED PER IRC 314.3 RATED WALL BETWEEN UNCONDITIONED GARAGE AND CONDITIONED HOUSE PER IRC
- R302.6
- SEE FOUNDATION PLAN FOR HOLD DOWN REQUIREMENTS


2018 WSEC COMPLIANCE NOTES

- GLAZING IS LESS THAN 25% OF CONDITIONED FLOOR AREA.
 - PRESCRIPTIVE OPTION 1 PER TABLE R402.1.1. PROVIDE MARKERS FOR BLOWN IN ATTIC INSULATION
- DUCTS OUTSIDE CONDITIONED SPACE WILL BE SEALED AND TESTED TO RS-33 PER IRC.
- DUCTS IN CONDITIONED SPACE WILL BE INSULATED 30 OS AS CLOSE AS POSSIBLE 8% TOTAL, 6% TO EXTERIOR OR LESS
- A CONTINUOUS ARE BARRIER SHALL BE INSTALLED ON BLDG. ENVELOPE, SEAL ALL
- CORNERS AND HEADERS TO BE INSULATED.
- SEAL GARAGE WALLS TO CONDITIONED SPACE, RECESSED LIGHTS ENVELOPE JAMBS. KNEE WALLS, TOP PLATES AND SILLS.
- INSULATE AROUND ALL PLUMBING, WIRING DEVICES, SHOWER STALLS, REGISTER
- BOOTS, FIRE PLACES (W/GASKET DOORS). A 5-2 DAY PROGRAMMABLE THERMOSTAT WILL BE PROVIDED FOR PRIMARY HVAC
- SYSTEM PER R402.1.1 ALL OTHER ADJUSTABLE.
- VAPOR RETARTER FOR BUILDING ENVELOPE PER R702.7 CLASS I OR II UNLESS EXCEPTIONS MET.
- LIGHTING: 75% OF ALL INTERIOR LIGHTS TO BE HIGH EFFICIENCY BLUBS PER R404. EXT. LIGHTING WILL BE ALL HIGH EFFICIENCY PER IRC.
- ALL FLOURESCENT BUDES WILL BE R-8 (1" DIA) ENERGY CODE COMPLIANCE CERTIFICATE POSTED PER R401.3, IN UTILITY ROOM OR
- OTHER APPROVED LOCATION
- NO WALL STACKS WILL BE CONTAINED IN ANY EXTERIOR WALL CAVITIES
- ALL RETURN AIR WILL BE DUCTED.
- BLOWER DOOR TEST IS MANDITORY PER 2018 WSEC TO <= 5 ACH@ 2 IN. PRESSURE /
- SIGNED REPORT
- WATER SUPPLY PIPING SHALL BE INSULATED R-3 MIN. EXHAUST OPENINGS MUST BE 3' AWAY FROM ALL OPENINGS
- MAX. EQUIVELANT LENGTH OF DRYER VENT IS 35'
 - VENTILATION: 135 CFM @ 65% RUN TIME PER M1507.3


ELEC. LEGEND



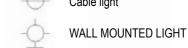

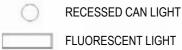



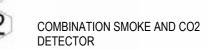

CASCADE

Architecture & Design

1405 POPLAR AVE. WENATCHEE, WASHINGTON p: 509-436-8227

e: kirsten@cascadearchitectureanddesign.com

KIRSTEN EHRHARDT 10/10/2022

STATE OF WASHINGTON

THESE DOCUMENTS ARE PROVIDED BY CASCADE ARCHITECTURE & DESIGN, FOR THE DESIGN INTENT

OF THIS SPECIFIC PROJECT AND ONLY THIS

RESPONSIBLE FOR ALL CONSTRUCTION COORDINATION, METHODS AND MATERIALS

REQUIRED FOR EXECUTION OF THESE DOCUMENTS

AND WORK OR MATERIALS SUPPLIED BY ANY SUBCONTRACTORS. ALL WORK SHALL COMPLY

WITH GOVERNING CODES AND ORDINANCES. THE

CONTRACTOR SHALL REVIEW AND UNDERSTAND

ALL DOCUMENTS AND SHALL NOTIFY THE

ARCHITECT IMMEDIATELY OF ANY DISCREPANCIES

IN THE DRAWINGS, FIELD CONDITIONS OR DIMENSIONS.


PROJECT NUMBER:

ISSUED/REVISION SCHEDULE

PERMIT

10.03.2022

LOWER LEVEL PLAN

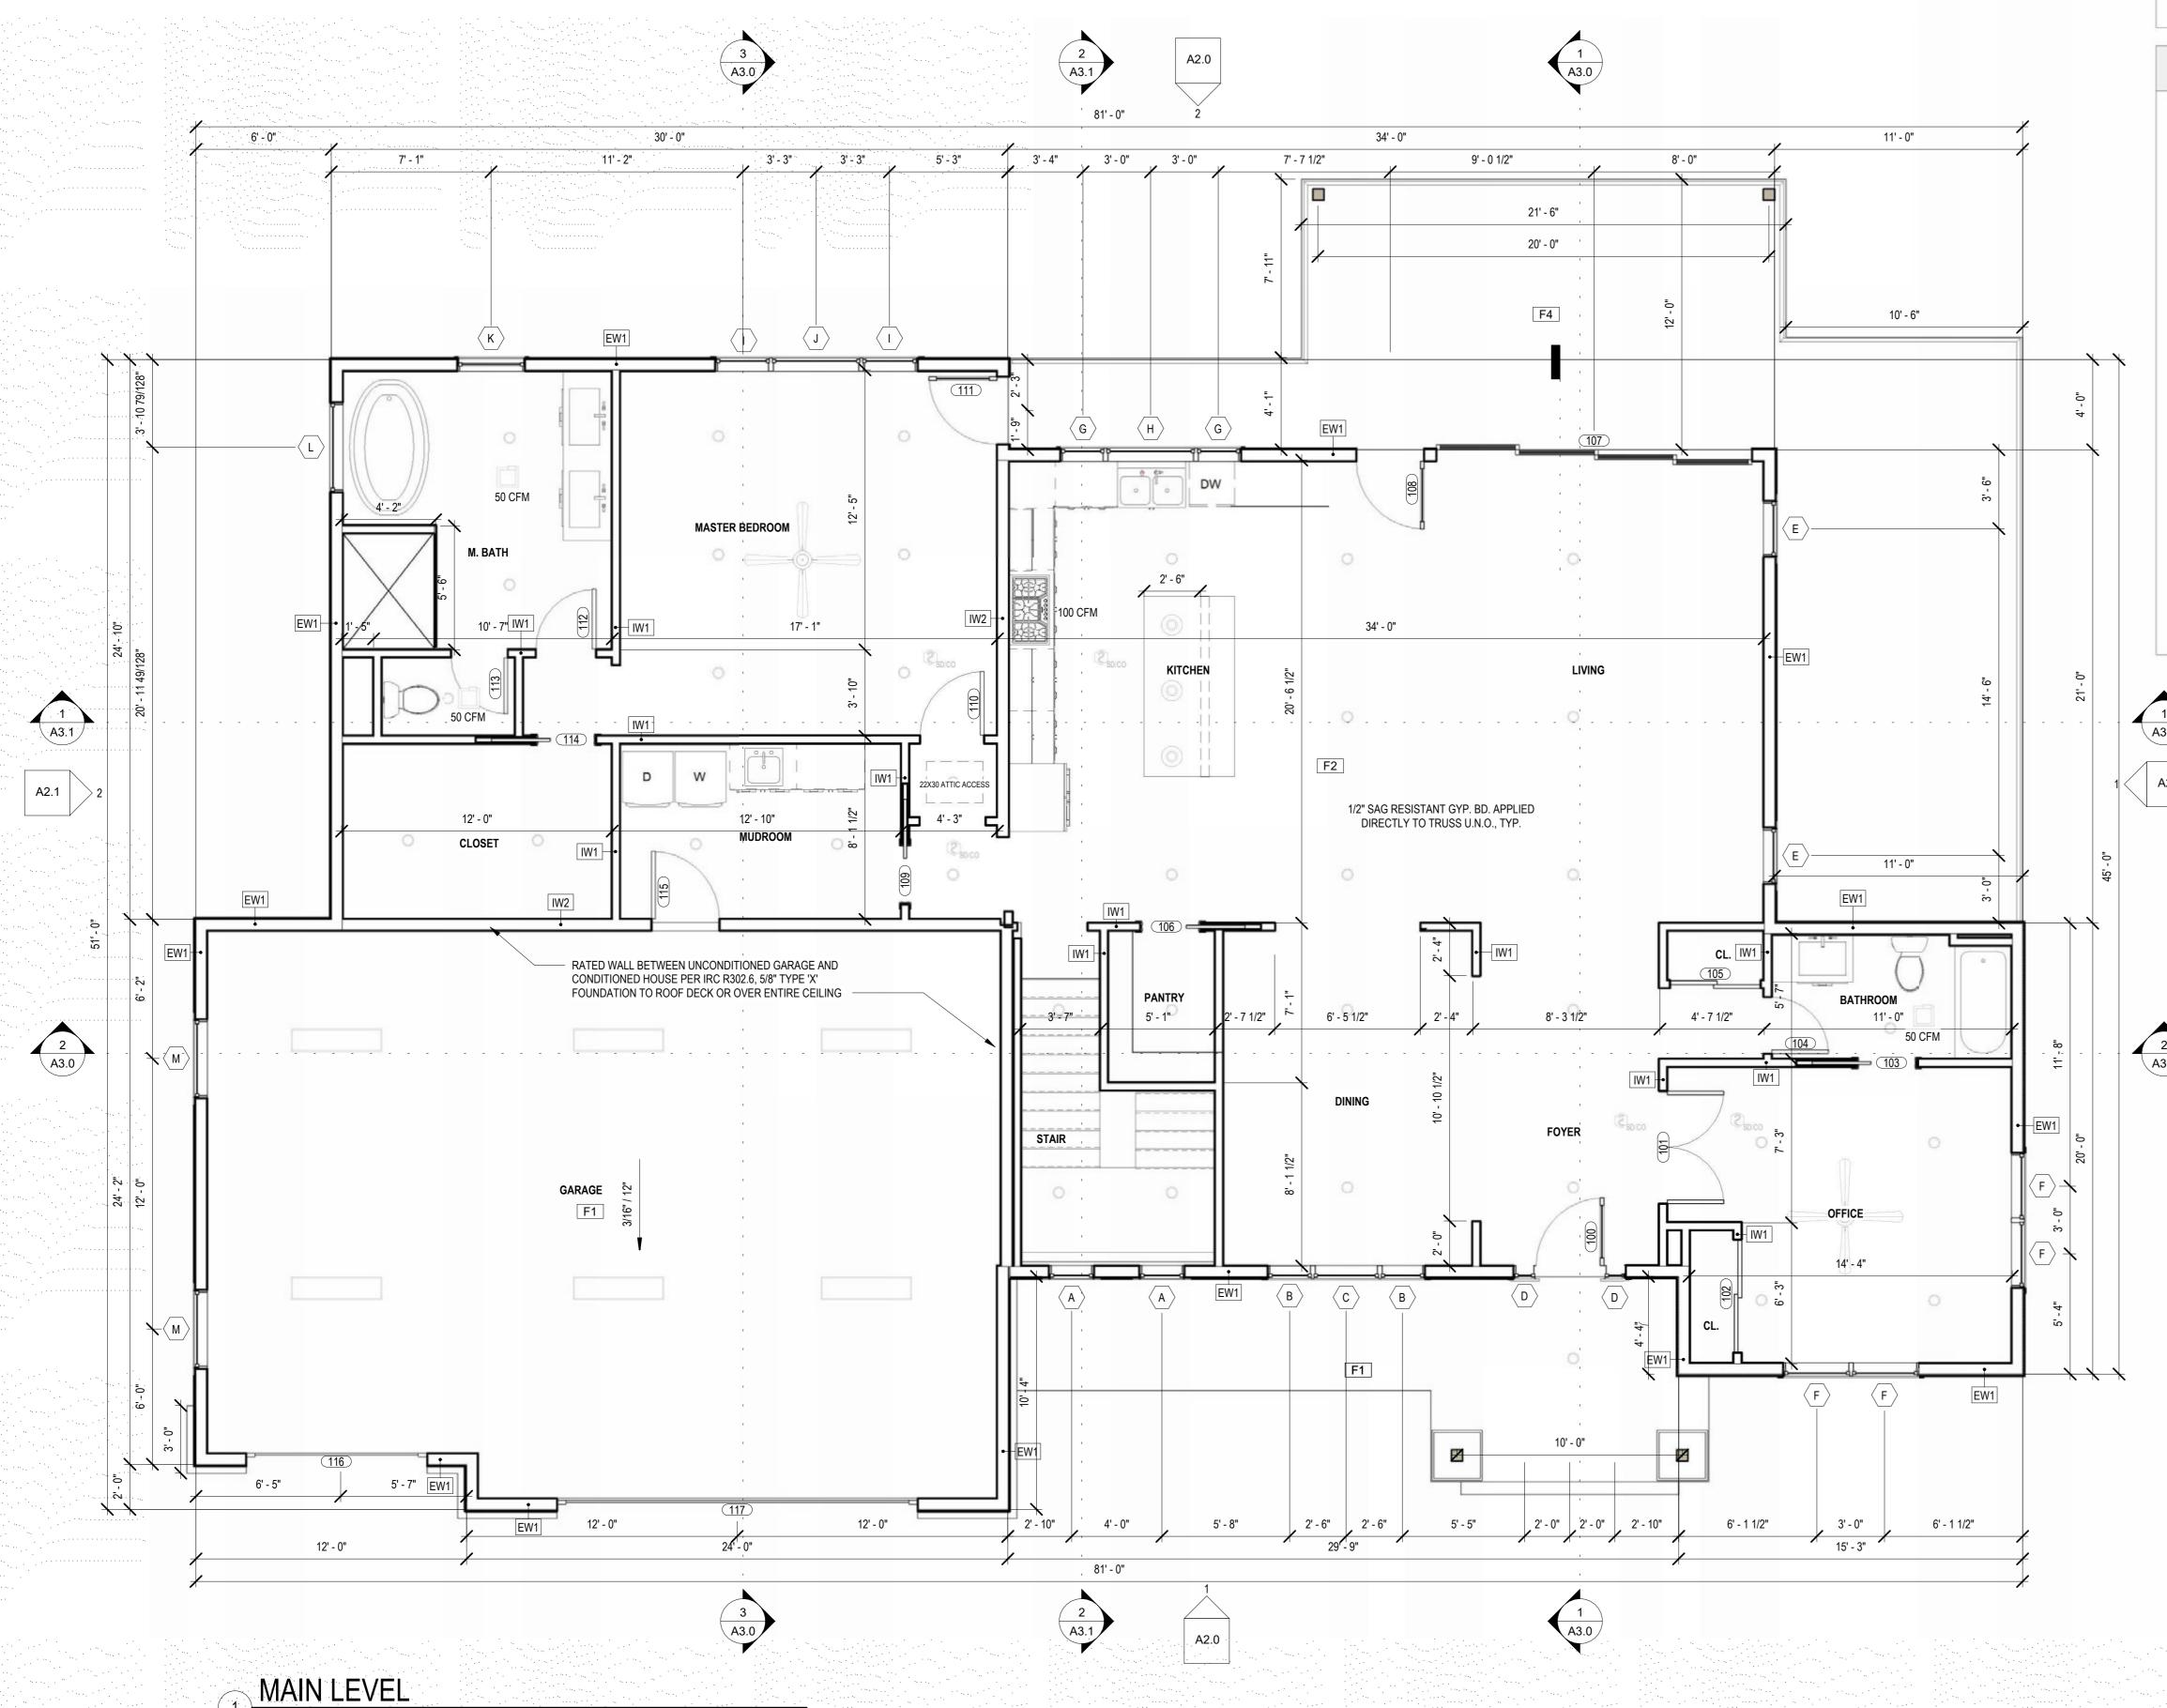

GENERAL PLAN NOTES

- 1. ALL EXTERIOR DIMENSIONS ARE TAKEN FROM FACE OF CONC. FOUNDATION WALL / F.O.S. U.N.O.
- 2. ALL INTERIOR DIMENSIONS ARE TAKEN FROM F.O.S. TO C.L. OF PARTITION U.N.O.
- DIMENSIONS INDICATING 'CLEAR' OR F.O.W. ARE TAKEN FROM FINISH
- 4. COMBINATION SMOKE/CARBON MONOXIDE DETECTORS TO BE ISTALLED PER IRC 314.3
- 5. RATED WALL BETWEEN UNCONDITIONED GARAGE AND CONDITIONED HOUSE PER IRC R302 6
- 6. SEE FOUNDATION PLAN FOR HOLD DOWN REQUIREMENTS

2018 WSEC COMPLIANCE NOTES

- GLAZING IS LESS THAN 25% OF CONDITIONED FLOOR AREA. PRESCRIPTIVE OPTION 1 PER TABLE R402.1.1.
- PROVIDE MARKERS FOR BLOWN IN ATTIC INSULATION
- DUCTS OUTSIDE CONDITIONED SPACE WILL BE SEALED AND TESTED TO RS-33 PER IRC.
- DUCTS IN CONDITIONED SPACE WILL BE INSULATED 30 OS AS CLOSE AS POSSIBLE 1. 8% TOTAL, 6% TO EXTERIOR OR LESS
- A CONTINUOUS ARE BARRIER SHALL BE INSTALLED ON BLDG. ENVELOPE, SEAL ALL
- CORNERS AND HEADERS TO BE INSULATED.
- SEAL GARAGE WALLS TO CONDITIONED SPACE, RECESSED LIGHTS ENVELOPE JAMBS, KNEE WALLS, TOP PLATES AND SILLS.
- INSULATE AROUND ALL PLUMBING, WIRING DEVICES, SHOWER STALLS, REGISTER
- BOOTS, FIRE PLACES (W/GASKET DOORS).

 A 5-2 DAY PROGRAMMABLE THERMOSTAT WILL BE PROVIDED FOR PRIMARY HVAC
- SYSTEM PER R402.1.1 ALL OTHER ADJUSTABLE.
- VAPOR RETARTER FOR BUILDING ENVELOPE PER R702.7 CLASS I OR II UNLESS
- EXCEPTIONS MET.
- LIGHTING: 75% OF ALL INTERIOR LIGHTS TO BE HIGH EFFICIENCY BLUBS PER R404.
- EXT_LIGHTING WILL BE ALL HIGH EFFICIENCY PER IRC.
- ALL FLOURESCENT BUDES WILL BE R-8 (1" DIA)
 ENERGY CODE COMPLIANCE CERTIFICATE POSTED PER R401.3, IN UTILITY ROOM OR OTHER APPROVED LOCATION
- NO WALL STACKS WILL BE CONTAINED IN ANY EXTERIOR WALL CAVITIES
- ALL RETURN AIR WILL BE DUCTED.
- BLOWER DOOR TEST IS MANDITORY PER 2018 WSEC TO <= 5 ACH@ 2 IN. PRESSURE / SIGNED REPORT
- WATER SUPPLY PIPING SHALL BE INSULATED R-3 MIN.
- EXHAUST OPENINGS MUST BE 3' AWAY FROM ALL OPENINGS
- MAX. EQUIVELANT LENGTH OF DRYER VENT IS 35'
 VENTILATION: 135 CFM @ 65% RUN TIME PER M1507.3

ELEC. LEGEND



PENDANT

WALL MOUNTED LIGHT

RECESSED CAN LIGHT

FLUORESCENT LIGHT

CEILING FAN W/ LIGHT

COMBINATION SMOKE AND CO2
DETECTOR

Area Sche	edu	ıle
Name		Area
GARAGE	917	SF

GARAGE 917 SF
MAIN LEVEL 2254 SF
LOWER LEVEL 2269 SF

ISSUED/REVISION SCHEDULE
DESCRIPTION AUTHOR DATE

Architecture & Design

1405 POPLAR AVE.
WENATCHEE, WASHINGTON

p: 509-436-8227
e: kirsten@cascadearchitectureanddesign.com

ARCHITECT

STATE OF WASHINGTON

THESE DOCUMENTS ARE PROVIDED BY CASCADE

OF THIS SPECIFIC PROJECT AND ONLY THIS

RESPONSIBLE FOR ALL CONSTRUCTION

COORDINATION, METHODS AND MATERIALS

REQUIRED FOR EXECUTION OF THESE DOCUMENTS

AND WORK OR MATERIALS SUPPLIED BY ANY

SUBCONTRACTORS. ALL WORK SHALL COMPLY WITH GOVERNING CODES AND ORDINANCES. THE

CONTRACTOR SHALL REVIEW AND UNDERSTAND

ALL DOCUMENTS AND SHALL NOTIFY THE ARCHITECT IMMEDIATELY OF ANY DISCREPANCIES

IN THE DRAWINGS, FIELD CONDITIONS OR

DIMENSIONS.

PROJECT NUMBER:

REST

ARCHITECTURE & DESIGN, FOR THE DESIGN INTENT

KIRSTEN EHRHARDT 10/10/2022

PERMIT 10.03.2022


SHEET NAME

MAIN LEVEL PLAN

GENERAL ROOF NOTES

Architecture & Design

1405 POPLAR AVE. WENATCHEE, WASHINGTON p: 509-436-8227
e: kirsten@cascadearchitectureanddesign.com

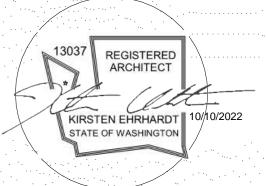

DISCLAIMER:
THESE DOCUMENTS ARE PROVIDED BY CASCADE
ARCHITECTURE & DESIGN, FOR THE DESIGN INTENT OF THIS SPECIFIC PROJECT AND ONLY THIS RESPONSIBLE FOR ALL CONSTRUCTION
COORDINATION, METHODS AND MATERIALS THE QUALITY OF WORKMANSHIP AND MATERIALS REQUIRED FOR EXECUTION OF THESE DOCUMENTS ... AND WORK OR MATERIALS SUPPLIED BY ANY SUBCONTRACTORS. ALL WORK SHALL COMPLY WITH GOVERNING CODES AND ORDINANCES. THE CONTRACTOR SHALL REVIEW AND UNDERSTAND ALL DOCUMENTS AND SHALL NOTIFY THE

IN THE DRAWINGS, FIELD CONDITIONS OR DIMENSIONS.

ARCHITECT IMMEDIATELY OF ANY DISCREPANCIES

PROJECT NUMBER:

CREST

ISSUED/REVISION SCHEDULE

PERMIT 10.03.2022

ROOF PLAN




CASCADE Architecture & Design

GENERAL ELEVATION NOTES

PROVIDE WINDOW VENTING OF 4% OF FLOOR AREA.

1405 POPLAR AVE.
WENATCHEE, WASHINGTON
p: 509-436-8227
e: kirsten@cascadearchitectureanddesign.com

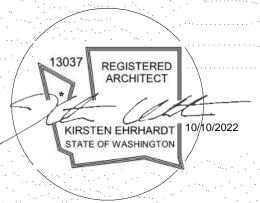

DISCLAIMER:

THESE DOCUMENTS ARE PROVIDED BY CASCADE ARCHITECTURE & DESIGN, FOR THE DESIGN INTENT OF THIS SPECIFIC PROJECT AND ONLY THIS PROJECT. THE CONTRACTOR SHALL BE RESPONSIBLE FOR ALL CONSTRUCTION COORDINATION, METHODS AND MATERIALS REQUIRED FOR THE SUCCESSFUL COMPLETION OF THE PROJECT. THIS INCLUDES BUT IS NOT LIMITED TO THE QUALITY OF WORKMANSHIP AND MATERIALS REQUIRED FOR EXECUTION OF THESE DOCUMENTS AND WORK OR MATERIALS SUPPLIED BY ANY SUBCONTRACTORS. ALL WORK SHALL COMPLY WITH GOVERNING CODES AND ORDINANCES. THE CONTRACTOR SHALL REVIEW AND UNDERSTAND ALL DOCUMENTS AND SHALL NOTIFY THE ARCHITECT IMMEDIATELY OF ANY DISCREPANCIES

IN THE DRAWINGS, FIELD CONDITIONS OR DIMENSIONS.

22.017

PROJECT NUMBER:

AUTUMN CREST DR.
870 AUTUMN CREST DR.
WENATCHEE, WA 98801


ISSUED/REVISION SCHEDULE

PERMIT

10.03.2022 SHEET NAME

ELEVATIONS

A2.0

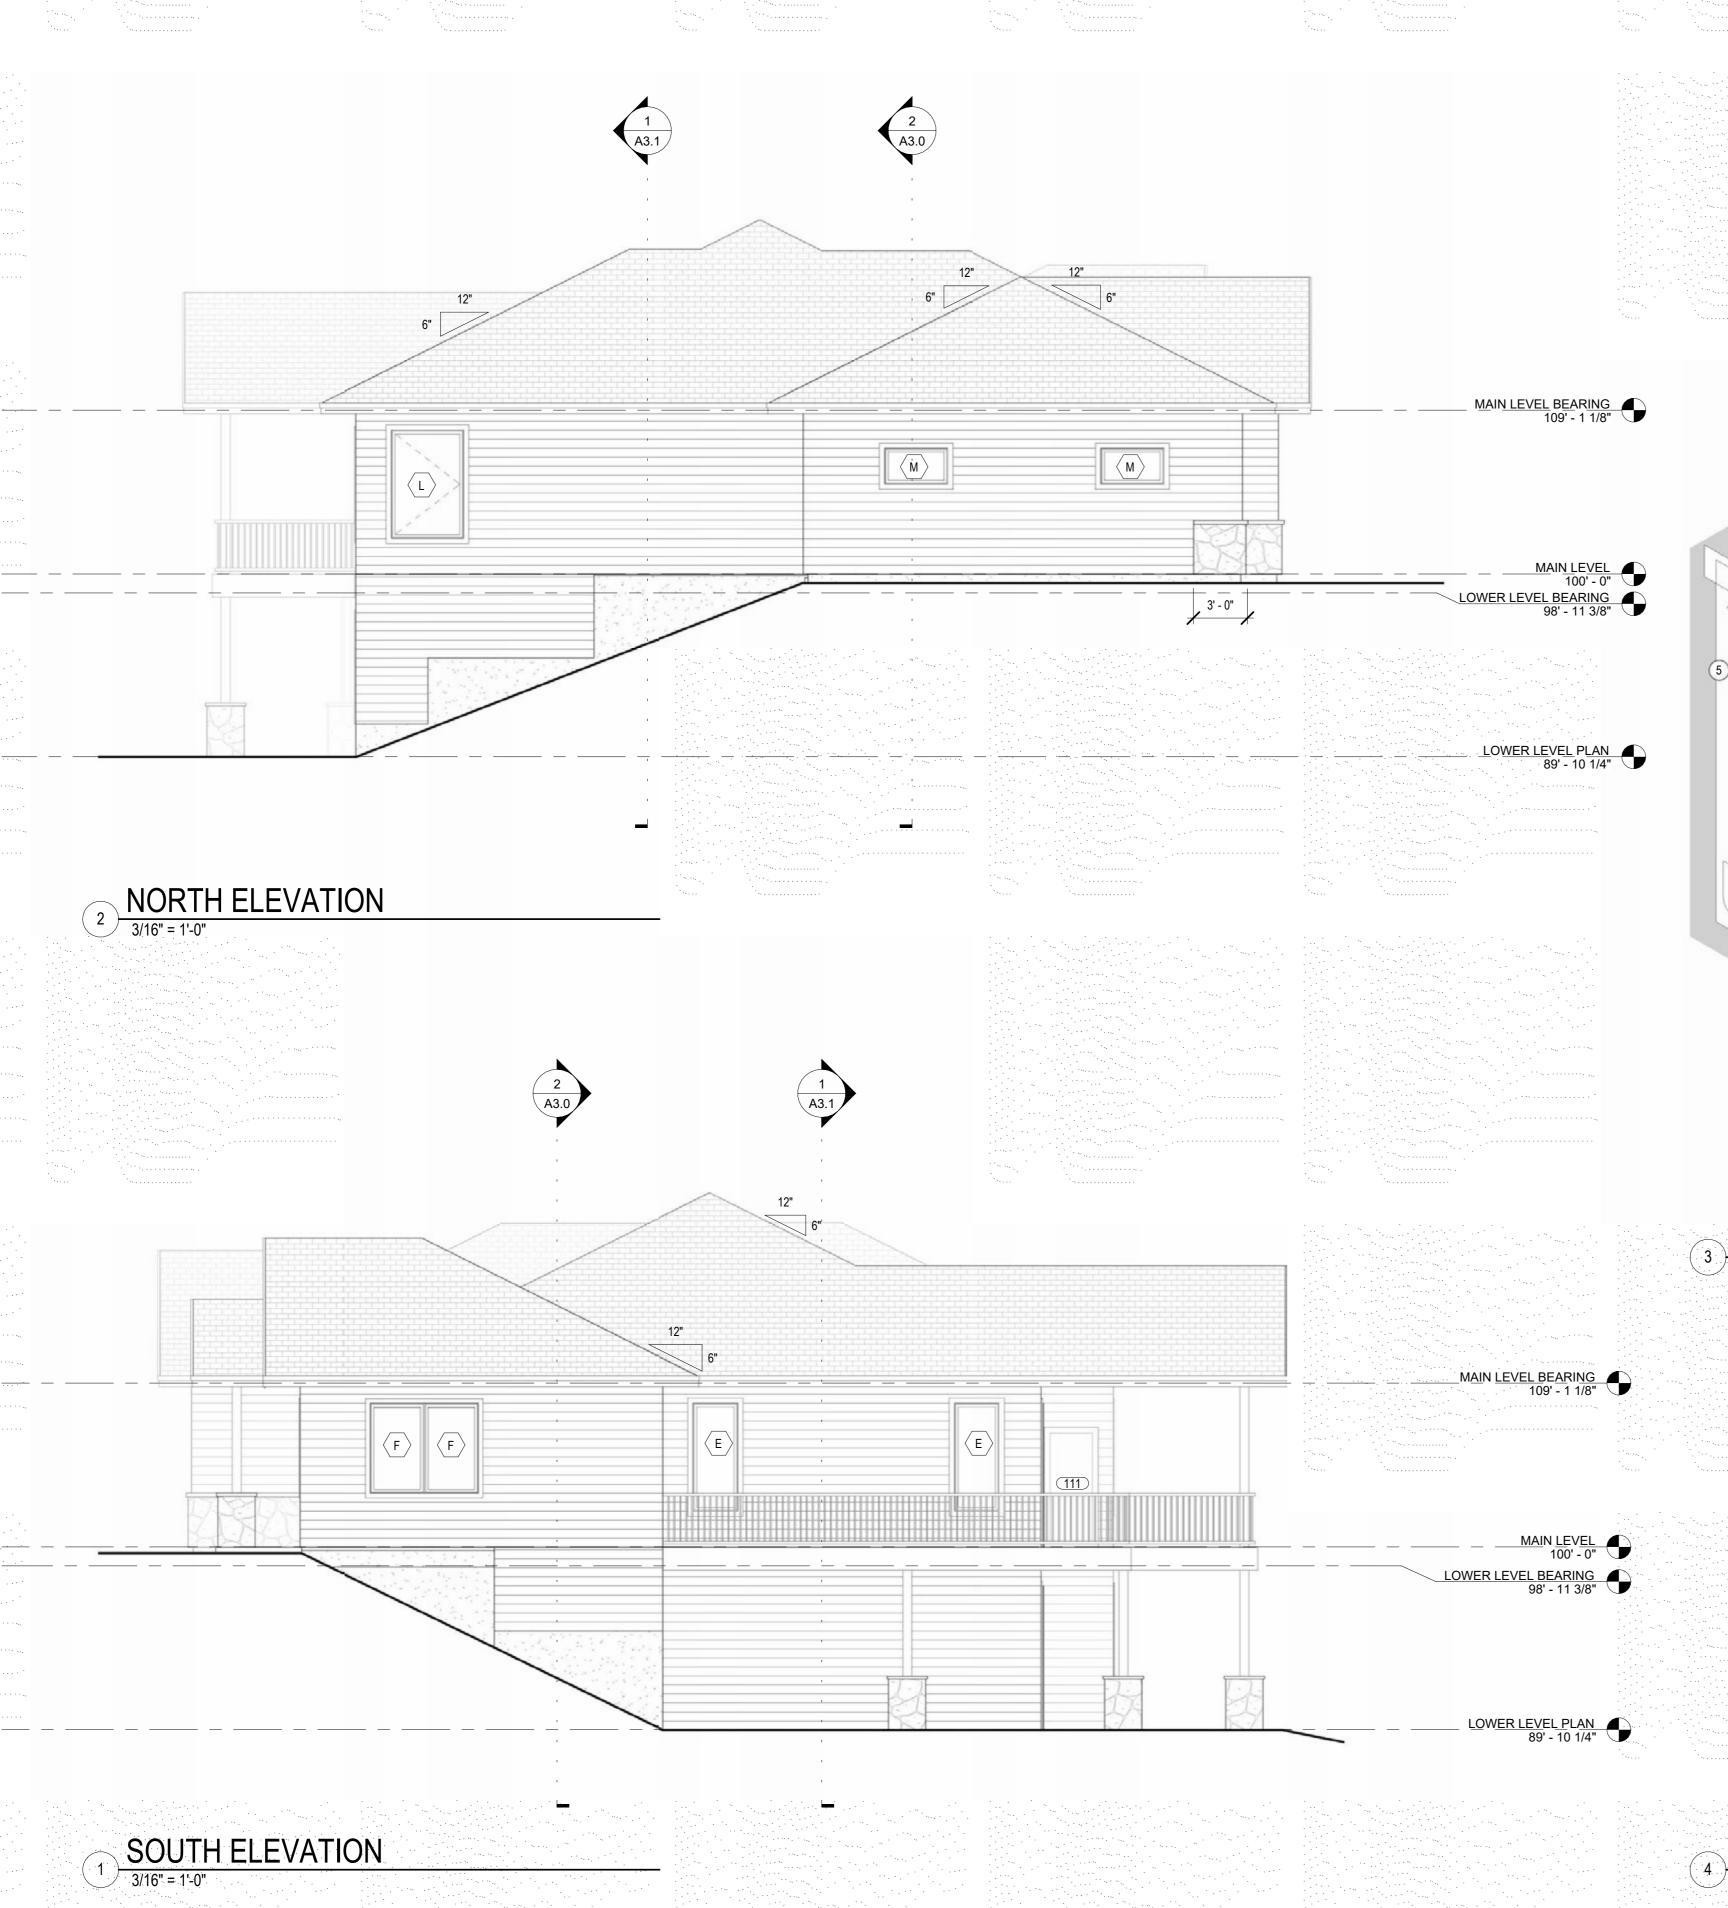

GENERAL ELEVATION NOTES

PROVIDE WINDOW VENTING OF 4% OF FLOOR AREA. PROVIDE NATURAL LIGHT AT 8% OF FLOOR AREA. PROVIDE 36" MIN. LANDING AT ALL EXT. DOOR NOT MORE THAN 7 3/4"

BELOW FINISHED FLOOR.

PROVIDE EACH SLEEPING ROOM WITH A EXTERIOR EXIT OR WINDOW OPENING PER R310. MIN. HEIGHT - 24"

> MIN. WIDTH - 20" MIN. AREA - 5 SF @ GRADE, 5.7 SF UPPER FLOORS MAX. 44" AFF

PROVIDE EXTERIOR FINISHES PER ELEVATIONS AND MATERIALS: ROOFING - ASPHALT SHINGLES OR EQUAL SIDING - FIBER CEMENT LAP SIDING WITH 6" EXPOSURE

SHAKE SIDING IN GABLE ENDS PER ELEVATIONS SYNTHETIC STONE WAINSCOT PER ELEVATIONS ALL OVER APPROVED BUILDING WRAP 1X4 FIBER CEMENT CORNER TRIM

1X3 OVER 5/4 X 8 FIBER CEMENT FASCIA 2X8 SMOOTH FIBER CEMENT HORZITONAL BAND BOARD PER ELEVATIONS

CONTINUOUS METAL GUTTERS TO METAL DOWNSPOUTS TO 4"

TIGHTLINE TO APPROVED STORMDRAIN FIBER CEMENT SOFFIT WITH INTEGRAL VENTS PER CODE

- AT HEAD INSTALL GALVANIZED METAL FLASHING TO OVER ZIP SYSTEM INSULATED WINDOW NAILING FIN SHEATHING & AIR/WEATHER ZIP SYSTEM INSULATED SHEATHING & AIR/WEATHER BARRIER GALVANIZED HEAD FLASHING INSTALL A CONTINUOUS BEAD OF CAULK AT HEAD AND JAMB SIDES SELF ADHERED FLEXIBLE SILL FLASHING 1. SELF ADHERED FLEXIBLE FLASHING AT SILL, WRAP UP SIDES OF WALL. 2. INSTALL A BEAD OF CAULK AT HEAD AND JAMB SIDES. 3. INSTALL WINDOW. 4. INSTALL GALVANIZED FLASHING AT HEAD.

WINDOW FLASHING DETAIL

IF OPEN RAIL IS USED THEN SPACE BALUSTERS SO A 4" SPHERE WILL NOT PASS THROUGH LSU 201 HANGER OR A35 EA. STRINGER, TYP. 6'-8" MIN. CLEARANCE TO NOSE OF TREAD -FIRESTOP ADJACENT WALLS PER 708.2 AT ALL STAIR LOCATIONS 1 1/4"-2" DIA. CONTINUOUS FULL LENGTH HANDRAIL WITH 1 1/2" MIN. SPACE TO WALL. RETURN ENDS TO WALL OR TERMINATE AT POST PER R311.7.9.2. RAIL 34" - 38" ABOVE STAIR NOSING 2X TREADS AND 1X RISERS GUARD/HANDRAIL TO SUSTAIN 200LB LOAD BALUSTERS TO SUSTAIN 50 LB LOAD

FROM NOSE OF TREAD 2X4 16" O.C. STUDDING ANCHORORED TO STRINGERS AND FLOOR GWB CONTINUOUS

5. INSTALL SELF ADHERED STRAIGHT FLASHING OVER NAILING FIN AT JAMB

NOTE: WINDOW FLASHING SHALL FOLLOW THIS SEQUENCE OR THE MANUFACTURER'S REQUIREMENTS, WHICHEVER IS MORE STRINGENT.

6. INSTALL SELF ADHERED STRAIGHT FLASHING OVER NAILING FIN AT WINDOW

- 36" WIDE MIN. LANDING LSU 210 HANGER OR A35

- 2X12 STRINGERS 10" TREAD (MIN 10") MAX. 7 3/4" RISERS WITH 3/4" TO 1 1/4" NOSING

FIREPROTECT ENCLOSED UNDER STAIR WALLS AND SOFFITS WITH 1/2" GWB/ FIRESTOP ADJACENT WALLS PER R302.11


6" SPHERE DOES NOT PASS THROUGH

- 4" SPHERE DOES NOT PASS THROUGH

STAIR DETAIL

Architecture & Design

1405 POPLAR AVE. WENATCHEE, WASHINGTON p: 509-436-8227 e: kirsten@cascadearchitectureanddesign.com

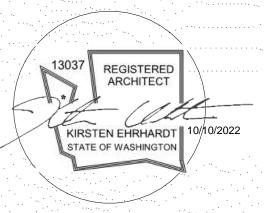

THESE DOCUMENTS ARE PROVIDED BY CASCADE ARCHITECTURE & DESIGN, FOR THE DESIGN INTENT OF THIS SPECIFIC PROJECT AND ONLY THIS RESPONSIBLE FOR ALL CONSTRUCTION

COORDINATION, METHODS AND MATERIALS REQUIRED FOR THE SUCCESSFUL COMPLETION OF THE QUALITY OF WORKMANSHIP AND MATERIALS REQUIRED FOR EXECUTION OF THESE DOCUMENTS AND WORK OR MATERIALS SUPPLIED BY ANY SUBCONTRACTORS. ALL WORK SHALL COMPLY WITH GOVERNING CODES AND ORDINANCES. THE CONTRACTOR SHALL REVIEW AND UNDERSTAND ALL DOCUMENTS AND SHALL NOTIFY THE ARCHITECT IMMEDIATELY OF ANY DISCREPANCIES IN THE DRAWINGS, FIELD CONDITIONS OR

22.017 PROJECT NUMBER:

DIMENSIONS.

REST /A 9 REST 870 A WENA


ISSUED/REVISION SCHEDULE DESCRIPTION AUTHOR DATE

> PERMIT 10.03.2022


SHEET NAME

ELEVATIONS



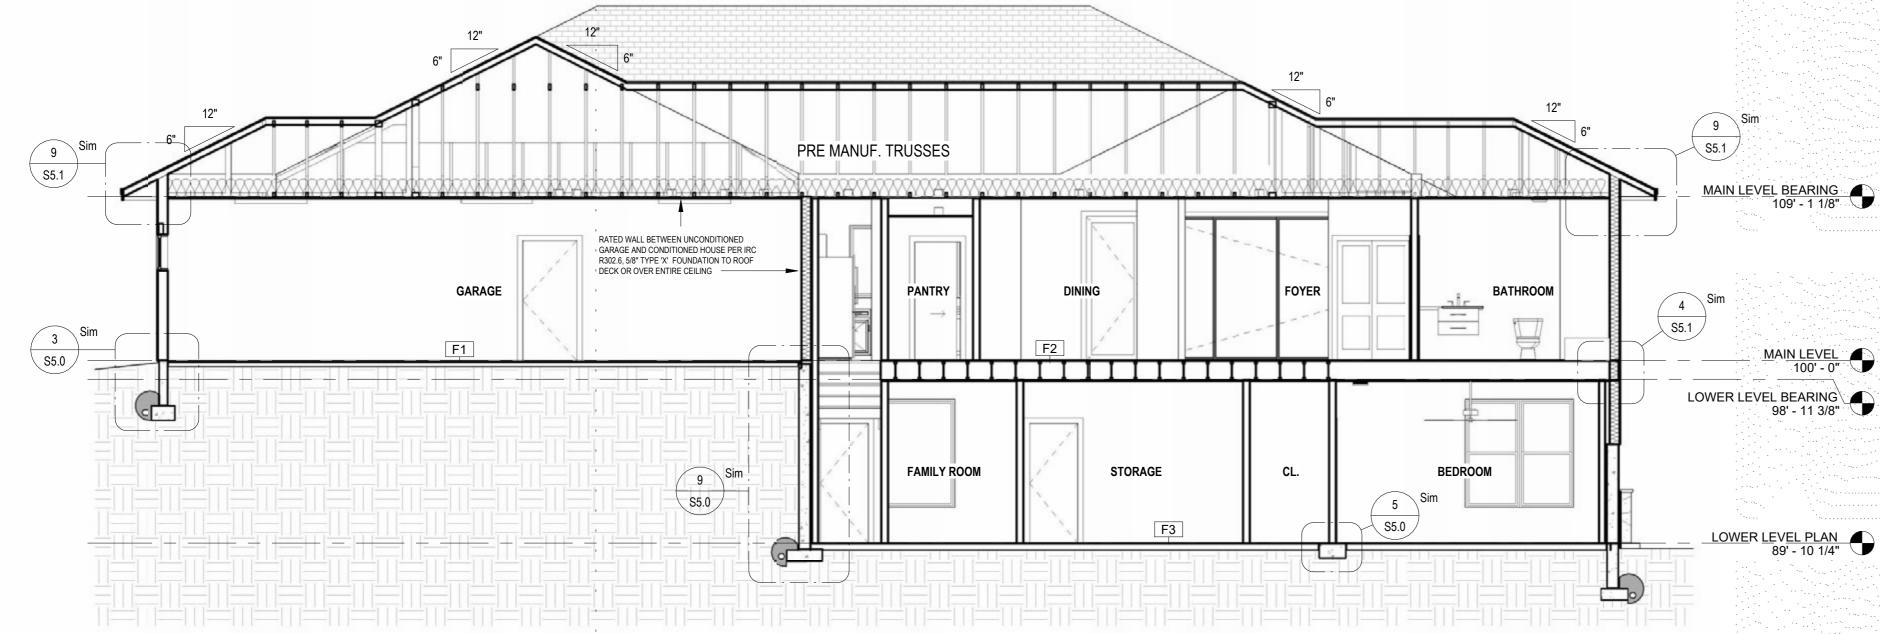


BUILDING SECTION 2

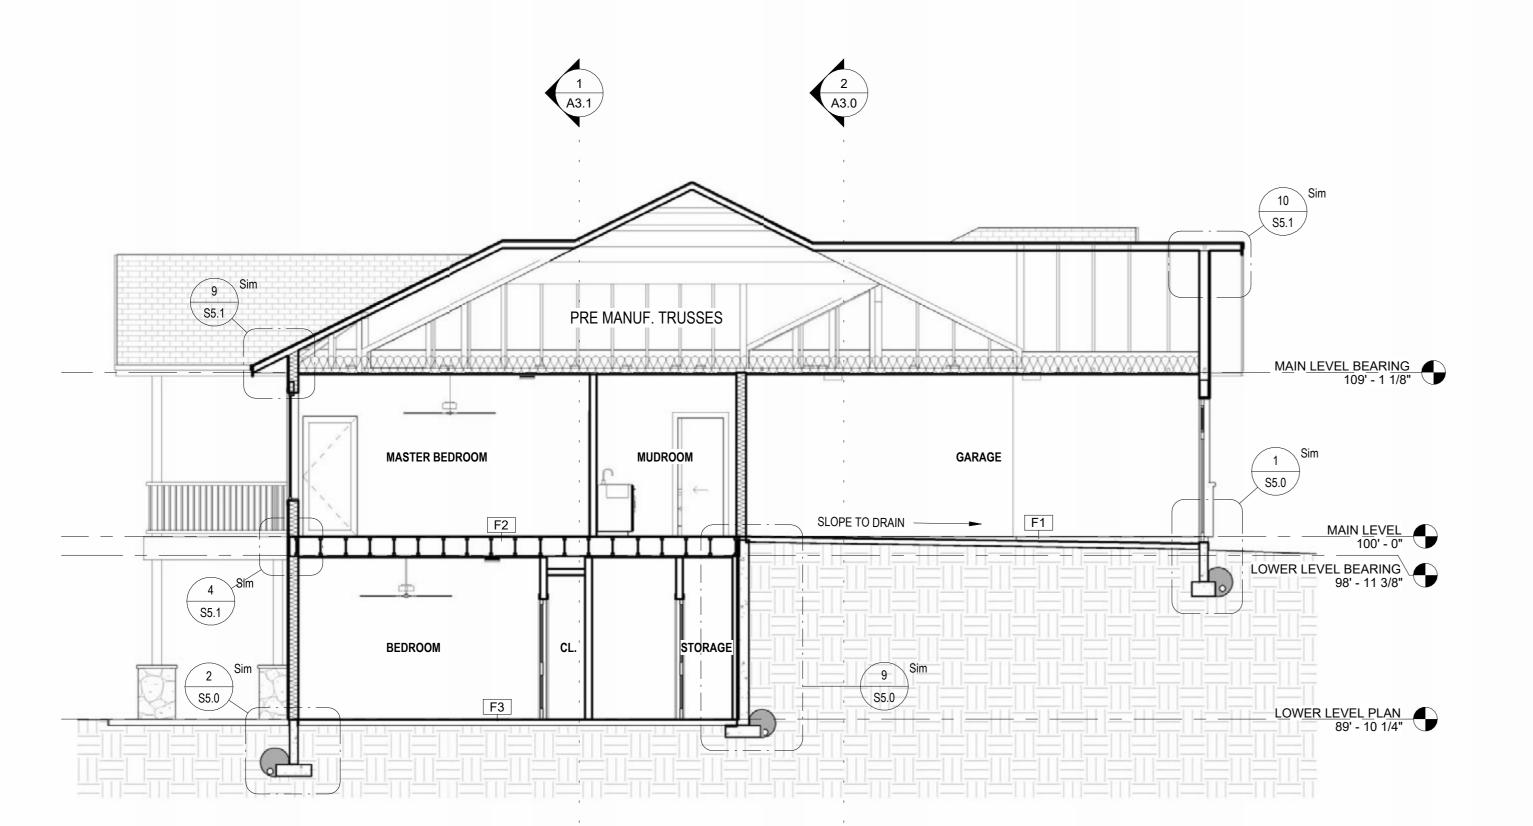

BUILDING SECTION 3


3/16" = 1'-0"

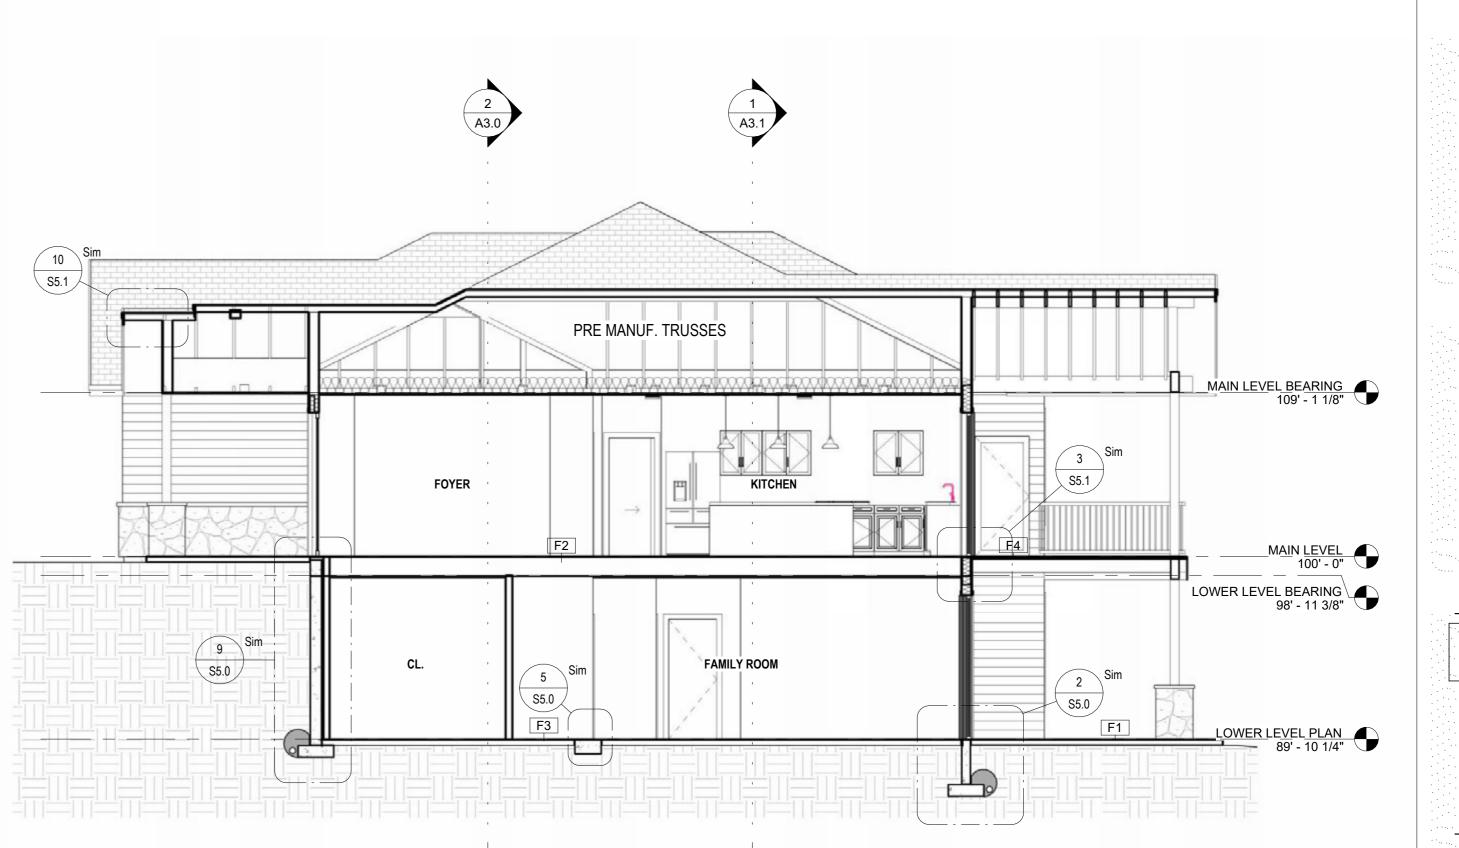

BUILDING SECTION 1
3/16" = 1'-0"

Architecture & Design

1405 POPLAR AVE. WENATCHEE, WASHINGTON p: 509-436-8227 e: kirsten@cascadearchitectureanddesign.com

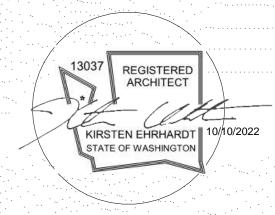

THESE DOCUMENTS ARE PROVIDED BY CASCADE ARCHITECTURE & DESIGN, FOR THE DESIGN INTENT OF THIS SPECIFIC PROJECT AND ONLY THIS PROJECT. THE CONTRACTOR SHALL BE RESPONSIBLE FOR ALL CONSTRUCTION COORDINATION, METHODS AND MATERIALS REQUIRED FOR THE SUCCESSFUL COMPLETION OF THE PROJECT. THIS INCLUDES BUT IS NOT LIMITED TO THE QUALITY OF WORKMANSHIP AND MATERIALS · REQUIRED FOR EXECUTION OF THESE DOCUMENTS . AND WORK OR MATERIALS SUPPLIED BY ANY SUBCONTRACTORS. ALL WORK SHALL COMPLY WITH GOVERNING CODES AND ORDINANCES. THE CONTRACTOR SHALL REVIEW AND UNDERSTAND ALL DOCUMENTS AND SHALL NOTIFY THE ARCHITECT IMMEDIATELY OF ANY DISCREPANCIES IN THE DRAWINGS, FIELD CONDITIONS OR

DIMENSIONS.

22.017

CREST DR. WA 98801

870 AUTUMN (WENATCHEE,

PROJECT NUMBER:

2 CREST

ISSUED/REVISION SCHEDULE DESCRIPTION AUTHOR DATE


PERMIT

10.03.2022 SHEET NAME


BUILDING SECTIONS

SHEET No.

A3.0

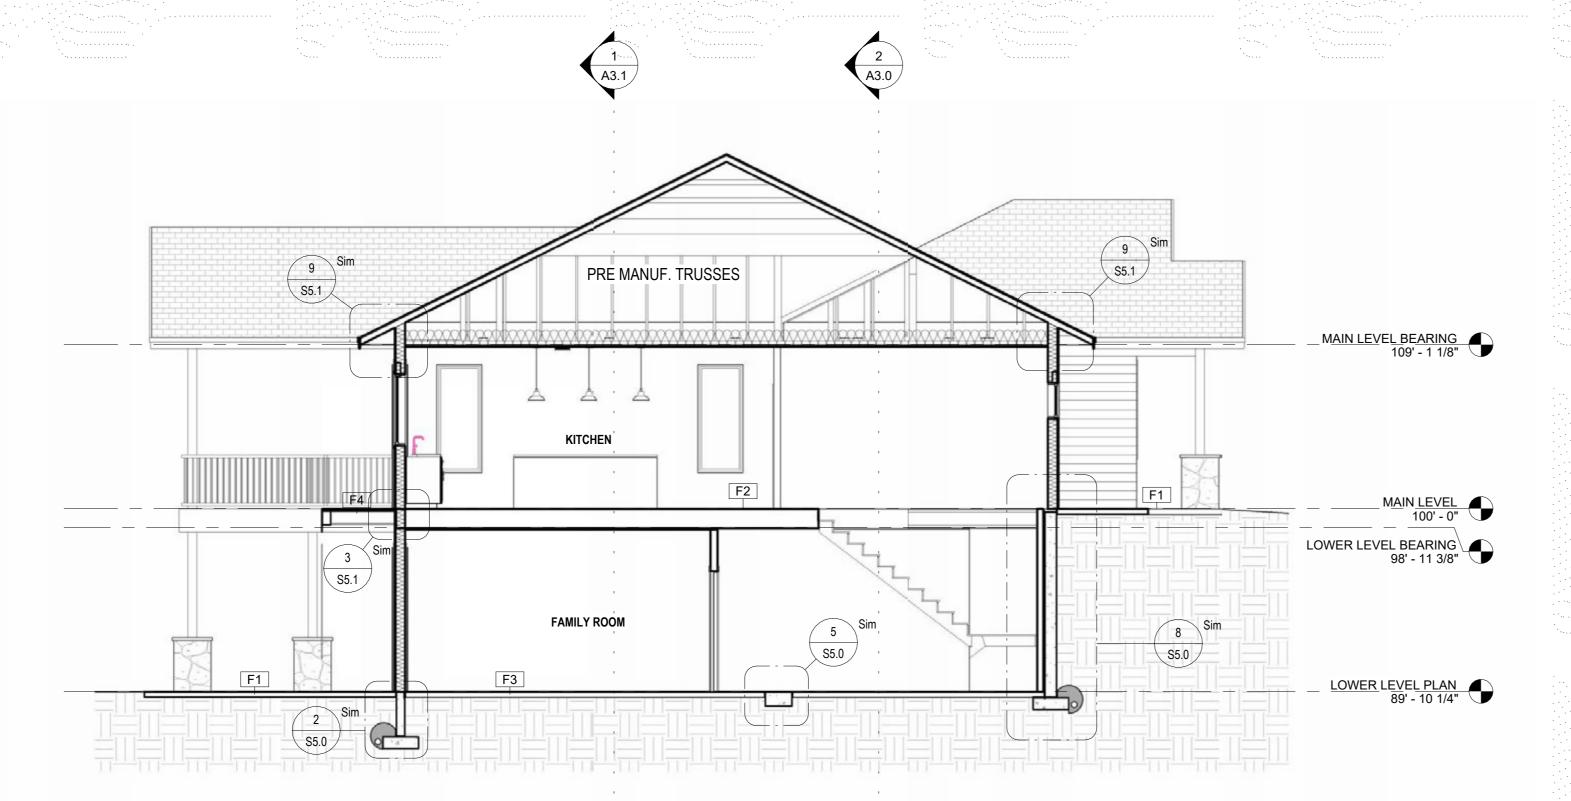

BUILDING SECTION 5 3/16" = 1'-0"

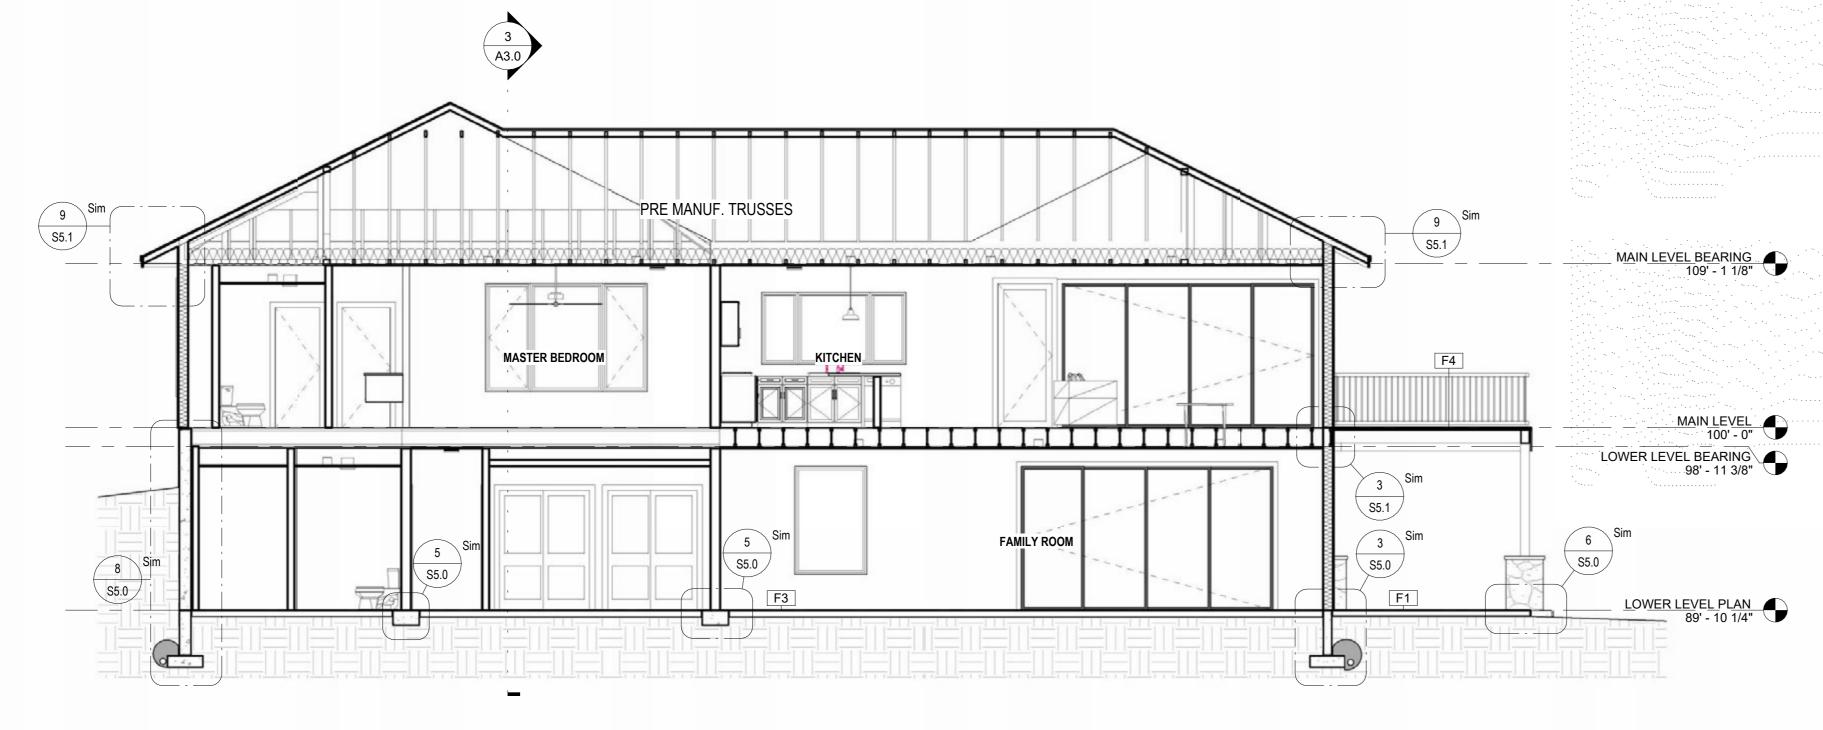

BUILDING SECTION 4

3/16" = 1'-0"

	DOOR SCI	HEDULE	
DOOR INFORMATION	DOO INFOR TION	MA HARDWARE	
	OOOR FIRE		OCKAPENTO

		DOOR	DOOR		DOOR		FIRE		
	DOOR#	WIDTH	HEIGHT	DOOR TYPE	MATERIAL	Finish	RATING	HARDWARE TYPE	COMMENTS
	LOWER LI	the state of the state of	N.			<u> </u>		·	
	001	14' - 0"	8' - 0"	FULL LITE SLIDING	FG	PRE FIN		BY MANUF.	
	002	2' - 8"	6' - 8"	HOLLOW CORE SWING	WOOD	PNT.		PASSAGE	
	003	2' - 8"	6' - 8"	HOLLOW CORE SWING	WOOD	PNT.		PASSAGE	
	004	2' - 8"	6' - 8"	HOLLOW CORE SWING	WOOD	PNT.		PRIVACY	
	005	5' - 0"	6' - 8"	HOLLOW CORE SLIDING	WOOD	PNT.		FINGER PULL	
	006	2' - 8"	6' - 8"	HOLLOW CORE POCKET	WOOD	PNT.		FINGER PULL	
	007	2' - 4"	6' - 8"	HOLLOW CORE SWING	WOOD	PNT.		PRIVACY	
	008	5' - 0"	6' - 8"	HOLLOW CORE SLIDING	WOOD	PNT.		FINGER PULL	
	009	5' - 0"	6' - 8"	HOLLOW CORE SLIDING	WOOD	PNT.	1.00	FINGER PULL	
	010	2' - 8"	6' - 8"	HOLLOW CORE SWING	WOOD	PNT.		PRIVACY	
	011	2' - 8"	6' - 8"	HOLLOW CORE SWING	WOOD	PNT.		PRIVACY	
	012	2' - 8"	6' - 8"	HOLLOW CORE SWING	WOOD	PNT.		PRIVACY	
	013	5' - 8"	6' - 8"	HOLLOW CORE SLIDING	WOOD	PNT.		FINGER PULL	
	014	2' - 8"	6' - 8"	HOLLOW CORE SWING	WOOD	PNT.		PRIVACY	
	015	5' - 0"	6' - 8"	HOLLOW CORE SLIDING	WOOD	PNT.	1.1.1.1.1.1.1.1	FINGER PULL	
	016	5' - 0"	6' - 8"	HOLLOW CORE SLIDING	WOOD	PNT.		FINGER PULL	
	017	2' - 0"	6' - 8"	HOLLOW CORE FOLDING	WOOD.	PNT.		FINGER PULL	
	018	2' - 8"	6' - 8"	······HOLLOW CORE SWING	WOOD	PNT.	***	PASSAGE	
	MAIN LEV	ĖĽ	******	·······	*****		*	.:	M
	100	3' - 0"	8' - 0"	FULL LITE SWING	FG	PRE FIN		PRIVACY W/ DEADBOLT	
	. 101 -	5' - 0"	6' - 8"	HOLLOW CORE DOUBLE SWING	.WOOD	PNT.		PASSAGE .	
· · · · .	102	5' - 0"	6' - 8"	HOLLOW CORE SLIDING	WOOD	PNT.		FINGER PULL	
٠	103	2' - 8"	6' - 8"	HOLLOW CORE POCKET	WOOD	PNT.		FINGER PULL	
	104	2' - 6"	6' - 8"	HOLLOW CORE SWING	WOOD	PNT.		PRIVACY	
	105	4' - 0"	6' - 8"	HOLLOW CORE SLIDING	WOOD	PNT.		FINGER PULL	
	106	2' - 8"	6' - 8"	HOLLOW CORE POCKET	WOOD	PNT.		FINGER PULL	
	107	14' - 0"	8' - 0"	FULL LITE SLIDING	FG	PRE FIN		BY MANUF.	
	108	3' - 0"	8' - 0"	FULL LITE SWING	FG	PRE FIN		PRIVACY W/ DEADBOLT	
٠	109	2' - 8"	6' - 8"	HOLLOW CORE POCKET	WOOD	PNT.		FINGER PULL	
	110	2' - 10"	6' - 8"	HOLLOW CORE SWING	WOOD	PNT.		PRIVACY	
	111 📜	3' - 0"	6' - 8"	FULL LITE SWING	FG	PRE FIN		PRIVACY W/ DEADBOLT	
	112	2' - 8"	6' - 8"	HOLLOW CORE SWING	WOOD	PNT.		PRIVACY	
	113	2' - 6"	6' - 8"	HOLLOW CORE SWING	WOOD	PNT.		PRIVACY	
	114	2' - 8"	6' - 8"	HOLLOW CORE POCKET	WOOD	PNT.		FINGER PULL	
	115	3' - 0"	6' - 8"	INSULATED SWING	FG	PRE FIN	20 MIN	PRIVACY W/ DEADBOLT	Sa
	116	8' - 0"	8' - 0"	OVERHEAD	FG	PRE FIN		BY MANUF.	

				V	VIND	OW SC	HEDULE		
						Head Height,			
. [Window #	Height	Width	Description	on	A.F.F.	Cor	mments	Count
• • <u> </u> L	OWER LEVEL P	PLAN							
	Κ	6' - 0"	3' - 0"	Double Hung		8' - 0"			4
	L	6' - 0"	<varies></varies>	<varies></varies>		8' - 0"			2
	0	6' - 0"	3' - 0"	Double Hung		8' - 0"			1, 1,
· · · · A	MAIN LEVEL								<u> </u>
<u></u>	Α	2' - 0"	2' - 0"	Fixed		7' - 0"			2
	B	6' - 0"	2' - 0"	Fixed		8' - 0"			· 2
	C	6' - 0"	· · · · · · 3' - 0"	Fixed		8' - 0"	· · ·		1
	D	8' - 0"	1' - 0"	Fixed		8" - 0"	•		2
L	E	6' - 0"	2' - 6"	Fixed		8' - 0"			2
	F	5' - 0"	3' - 0"	Fixed		8' - 0"		<u> </u>	4
· · · · <u>.</u>	G	4' - 0"	2' - 0"	Fixed		7' - 6"			2
	Н	4' - 0"	4' - 0"	Fixed		7' - 6"			1
	1	6' - 0"	2' - 6"	Casement	<u> </u>	8' - 0"			2
	J ·	6' - 0"	4' - 0"	Fixed		8' - 0"			1
	K	6' - 0"	3' - 0"	Double Hung		8' - 0"			1
	L	6' - 0"	4' - 0"	Casement		8' - 0"			1
· L	М	2' - 0"	3' - 6"	Fixed		7' - 0"			2
				100000000000000000000000000000000000000			the control of the co		ar an


BY MANUF.

E - EGRESS WINDOW PER ELEVATIONS

OVERHEAD

CASCADE Architecture & Design

1405 POPLAR AVE.
WENATCHEE, WASHINGTON
p: 509-436-8227
e: kirsten@cascadearchitectureanddesign.com

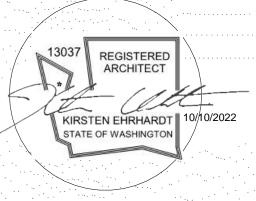

THESE DOCUMENTS ARE PROVIDED BY CASCADE ARCHITECTURE & DESIGN, FOR THE DESIGN INTENT OF THIS SPECIFIC PROJECT AND ONLY THIS PROJECT. THE CONTRACTOR SHALL BE RESPONSIBLE FOR ALL CONSTRUCTION
COORDINATION, METHODS AND MATERIALS REQUIRED FOR THE SUCCESSFUL COMPLETION OF THE PROJECT. THIS INCLUDES BUT IS NOT LIMITED TO THE QUALITY OF WORKMANSHIP AND MATERIALS · REQUIRED FOR EXECUTION OF THESE DOCUMENTS ... AND WORK OR MATERIALS SUPPLIED BY ANY SUBCONTRACTORS. ALL WORK SHALL COMPLY WITH GOVERNING CODES AND ORDINANCES. THE CONTRACTOR SHALL REVIEW AND UNDERSTAND ALL DOCUMENTS AND SHALL NOTIFY THE ARCHITECT IMMEDIATELY OF ANY DISCREPANCIES IN THE DRAWINGS, FIELD CONDITIONS OR DIMENSIONS.

PROJECT NUMBER:

22.017

AUTUMN CREST 2.0
870 AUTUMN CREST DR.
WENATCHEE, WA 98801

ISSUED/REVISION SCHEDULE
DESCRIPTION AUTHOR DATE


PERMIT 10.03.2022

SHEET NAME

BUILDING SECTIONS

SHEET No.

A3.1

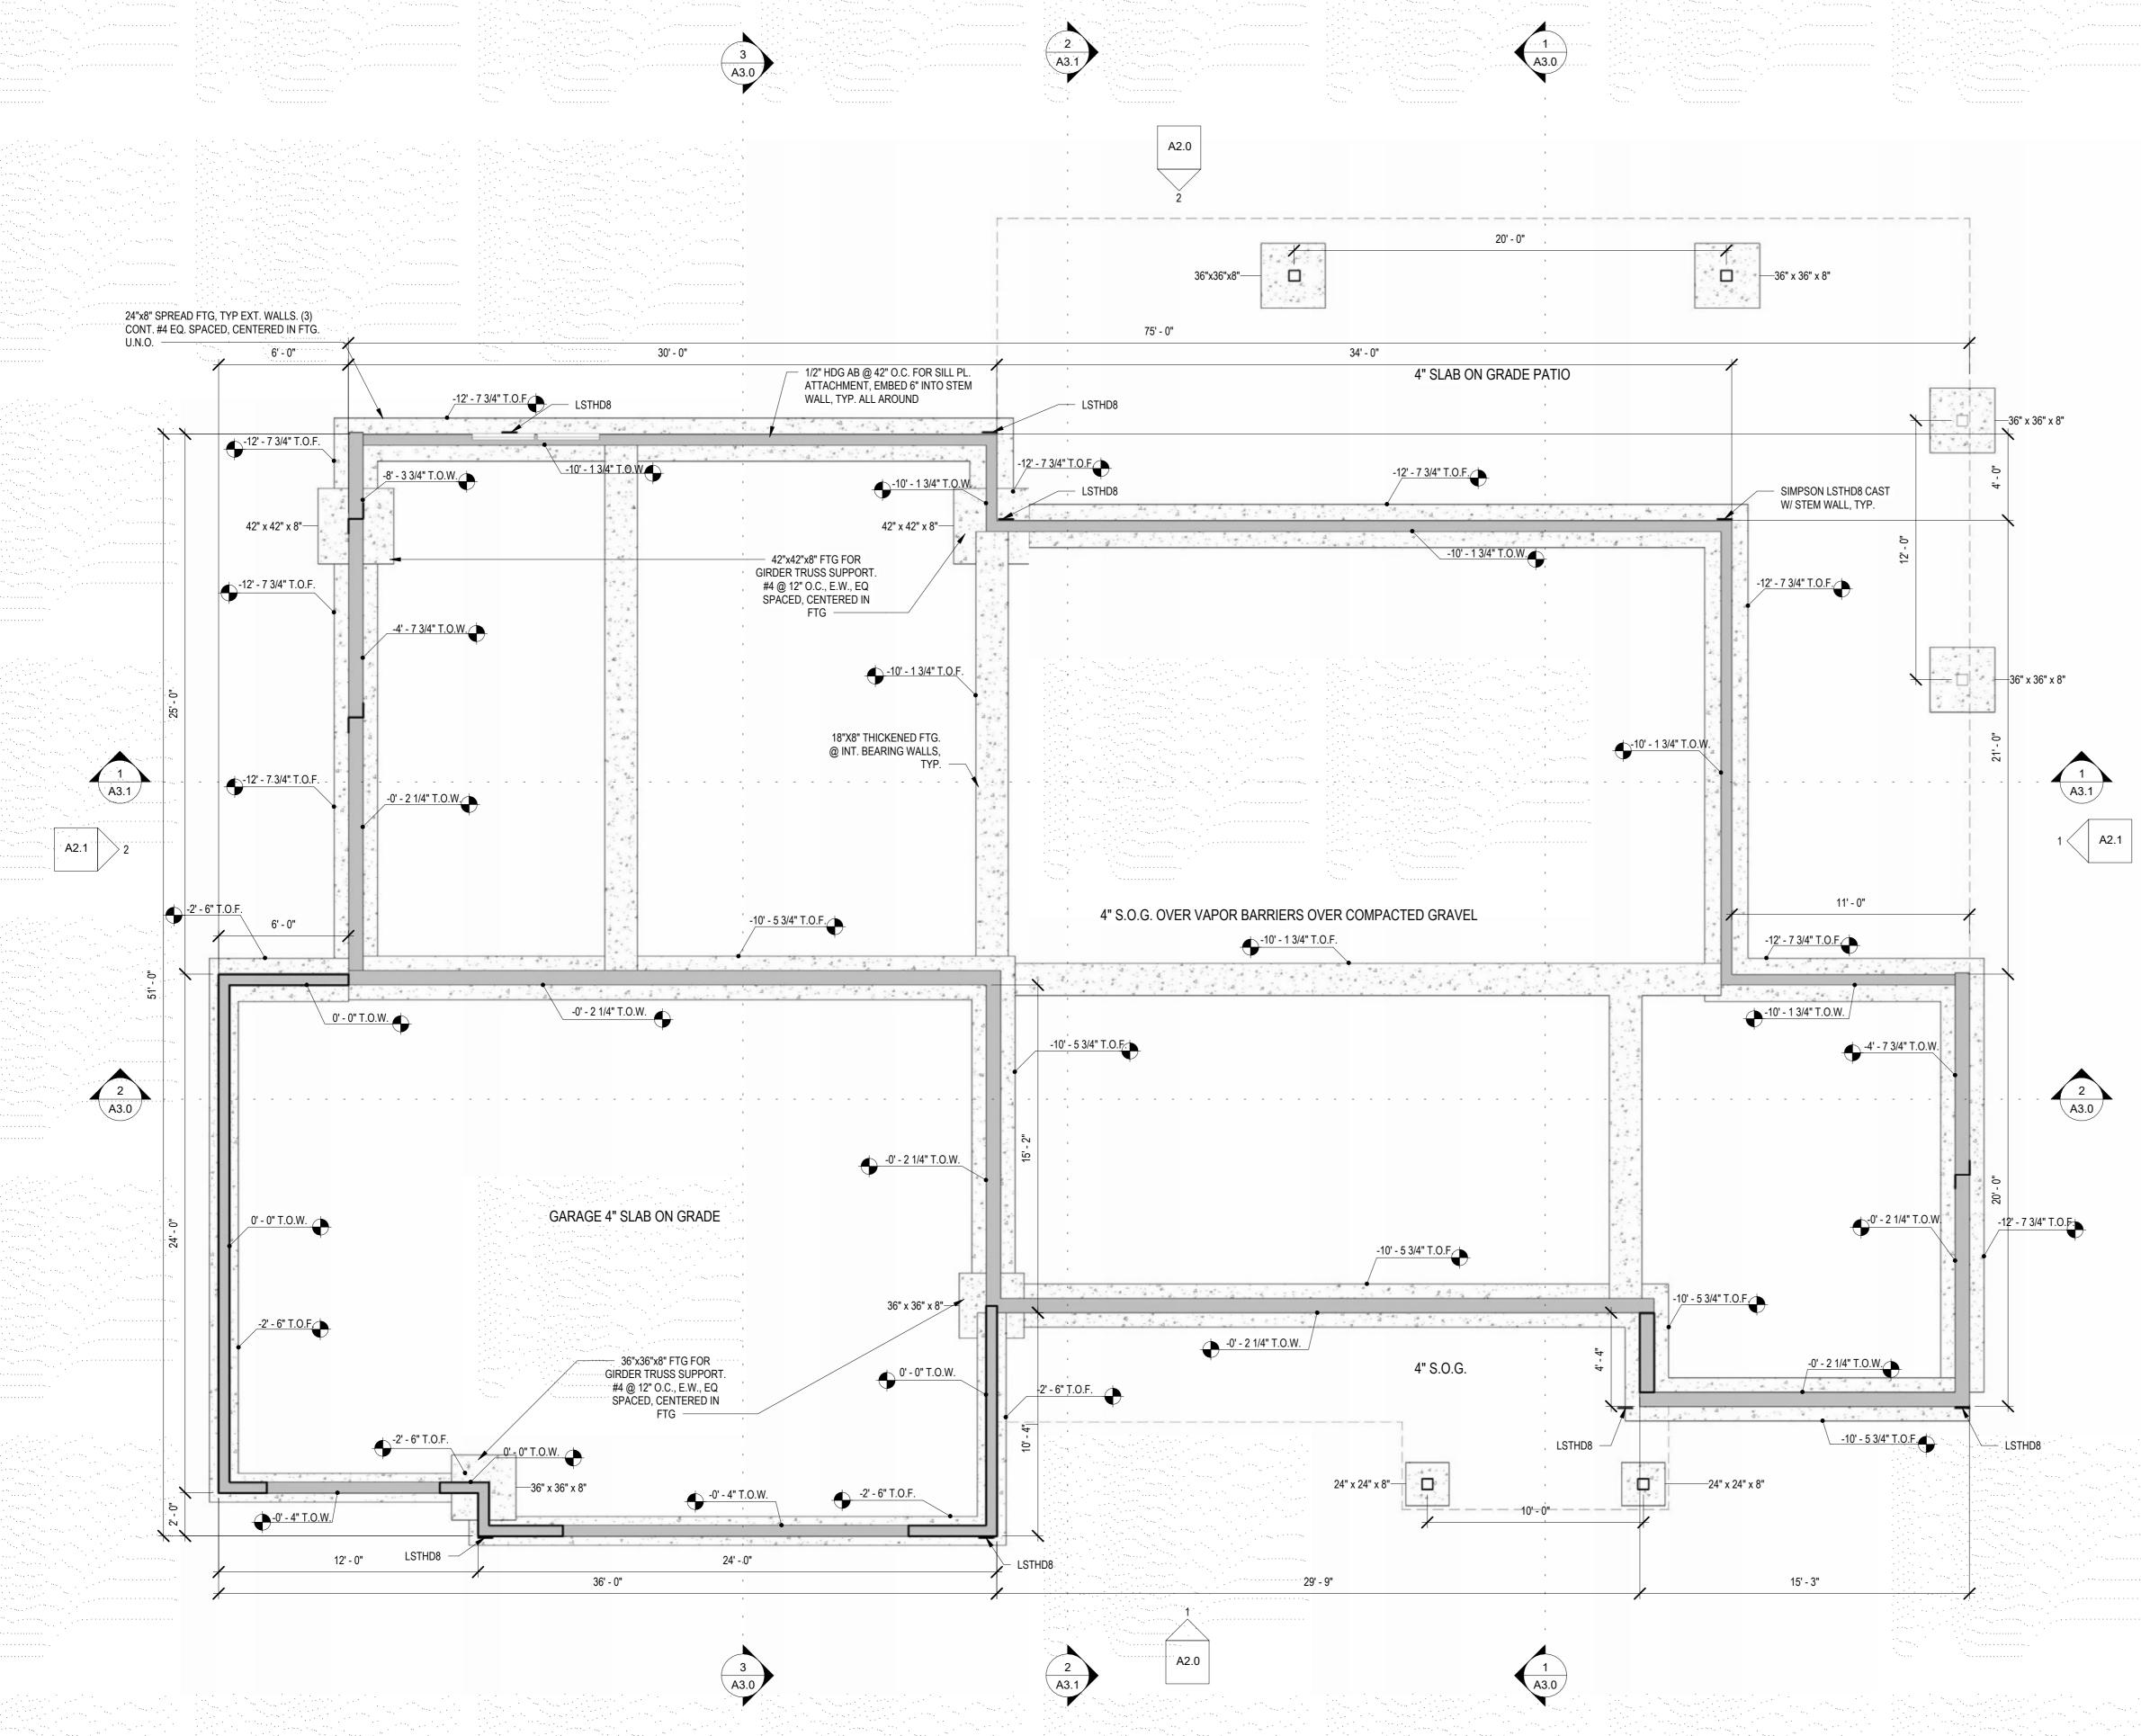

FOUNDATION PLAN

STRUCTURAL NOTES:

ALL CONSTRUCTION SHALL CONFORM TO THE INTERNATIONAL BUILDING CODE (IBC) 2018 EDITION OR OTHER GOVERNING CODE, AS REQUIRED BY LOCAL JURISDICTION.

NO SPECIAL INSPECTIONS ARE REQUIRED. NOTIFY BUILDING DEPARTMENT FOR INSPECTIONS REQUIRED BY LOCAL JURISDICTION.

THE CONTRACTOR SHALL VERIFY DIMENSIONS AND CONDITIONS AT JOB SITE. THE CONTRACTOR SHALL PROVIDE TEMPORARY BRACING AS REQUIRED UNTIL ALL PERMENANT CONNECTIONS AND STIFFENING HAVE BEEN INSTALLED.

DO NOT SCALE DRAWINGS PREFABRICATED ITEMS TO BE HANDLED AND INSTALLED PER MANUFACTURERS RECOMMENDATIONS.

ALL CONCRETE SHALL HAVE MIN 2500 PSI 28-DAY COMPRESSIVE STRENGTH. ALL REINFORCING STEEL, EMBEDDED METAL CONNECTORS, ANCHOR BOLTS, AND INSERTS EMBEDDED IN CONCRETE SHALL BE ACCURATELY PLACED AND SECURED PRIOR, AND SHALL BE HOT DIPPED GALVANIZED

FOR ALL LOAD BEARING FOOTINGS, REMOVE EXISTING EXPANSIVE SOIL TO MIN 36" DEEP AND REPLACE IWTH NON-EXPANSIVE STRUCTURAL FILL AND COMPACT TO 95% MAX DRY DENSITY PER ASTM D-1557 MODIFIED

ALL CONCRETE SLABS SHALL BE 5" THICK HAVING 28 DAY COMPRESSIVE STRENGTH OF 2500 PSI OR GREATER. PROVIDE TOOLED JOINTS @ 15 FT MAX EA WAY.

WELDED WIRE MESH TO BE A-185 OR EQUAL WHERE NOTED, CONCRETE SIDEWALKS SHALL SLOPE 1/4" PER FT

REINFORCING STEEL SHAL LBE ASTM A615 GRADE 40 OR BETTER

REINFORCING:

(2) #4 CONTINUOUS IN SPREAD FTG, (1) AT TOP OF WALL. #4 VERT @ MAX 18" O.C.

24" MAX HEIGHT FOR STANDARD FND WALL PROVIDE #4 @ 10" O.C. HORZ, 16" O.C VERTS IN STEM WALL

UNDER FLOOR INSPECTION REQUIRED ALL HOLDOWNS, FRAMING, ANCHORS AND SHEARWALLS MUST BE INSPECTED BEFORE COVERING. PROVISION SHALL BE MADE TO PREVENT WATER FROM COLLECTING IN CRAWL SPACES AND FROM LEAKING

ONTO BASEMENT FLOORS. ANCHOR BOLT WASHERS SHALL BE 3"x3"x1/4" THICK PER R602.11.1. BOLTS SHALL BE NOT LESS THAN 7 BOLT DIAMETERS, AND NOT MORE THAN 12" FROM THE ENDS OF EACH INDIVIDUAL FOUNDATION SILL PLATE.

MIN 6" EMBEDMENT INTO STEM WALL MIN (2) PER SILL PLATE SPACING PER FOUNDATION PLAN

ANY CHANGES TO FLOOR FRAMING (I.E. I-JOIST FROM SOLID SAWN) WILL REQUIRE NEW FLOOR FRAMING

18" MIN CRAWL SPACE 12" MIN CLEARANCE AT BEAMS 6 MIL BLACK FISQ VAPOR BARRIER F.G. INSULATION UP TO SUBFLOOR

STUB OUT \$4 REBAR @ 18" O.C. AT CONC PORCH TO RESIST DIFFERENTIAL SETTLEMENT OR PROVIDE PT RIM AT PATIOS

COLUMN & BEAM NOTES: COLUMNS TO BE 4X4 U.N.O COLUMN BASES +8" ABOVE GRADE OR PT PROTECT COLUMN BASE W/ FHA12 OR EQUAL. COL-BM POSI CONNECTION PER R407.3 1" MIN AIR SPACE BETWEEN WOOD AND CONCRETE OR USE PT LUMBER LAMINATE MULTI JOISTS W/ 2 ROWS 18d @ 16" O.C. STAGGER T&B - STUDS AND GENERAL FRAMING SHALL BE HEM FIR OR SPF - GLULAM BEAMS SHALL BE GRADE 24F-V4 DF/DF - STRUCTURAL SOLID SAWN FRAMING (HEADERS/BEAMS) SHALL

BE DOUGLAS FIR LARCH #2 OR BETTER.

TYPICAL FLOOR SHEATHING: 3/4" T&G, CDX PLYWOOD INDEX 40/20, UNBLOCKED, LAID UP W/ FACE GRAIN PERPENDICULAR TO FRAMING BELOW, STAGGER END JOINTS. NAIL AS FOLLOWS: DIAPHRAM BOUNDARY AND OVER 8D @ 6" O.C. 8D @ 6" O.C. EXTERIOR WALLS AND SHEAR WALLS: ALL SUPPORT EDGES:

8D @ 10" O.C. STRUCTURAL 1 GRADE, CONFORMING TO U.S. PRODUCT STANDARDS PS I AND SHALL BE PRESSURE

FRAMING/SHEATHING LUMBER:

FIELD PROTECT ALL CUT SURFACES OF LUMBER WITH PRESERVATIVE WHICH SHALL BE APPLIED IN ACCORDANCE WITH MANUF.S RECOMMENDATIONS. CONTRACTOR TO PROVIDE ADEQUATE BRACING ADN SHORING FOR ALL STRUCTURAL MEMBERS DURING ALL PHASES OF CONSTRUCTION.

LOAD PATH FROM ROOF TO FOUNDATION TO RESIST HIGH WIND FORCES. ALL FINISH SURFACES SHAL RECIEVE 1 COAT PRIME AND 2 COATS FINISH PAINT.

STRUCTURAL TIMBER SHAL BE DF/L SPECIES METTING FOLLOWING MIN. GRADE/STRESSES AS EST. BY THE WESTERN WOOD PRODUCTS ASSOCIATION. BEAMS & HEADERS: DFL2

GLULAM: 24F-V4 STUDS & PLATES: HF OR SPF STUD

TRUSS DRAWINGS:

FIELD:

TREATED.

BY MANUFACTURER. BY THE TRUSS PLATE INSTITUTE (TPI). ALL TRUSSES SHALL BE PRESERVATIVE TREATED DF MEETING MIN.

SHEAR WALL SCHEDULE: - 3/8" SHEATHING GRADE PANELS - 8d NAILS @ 6" O.C. AT PANEL EDGES - 8d NAILS @ 12" O.C. FIELD - TYP ALL EXTERIOR WALLS

Architecture & Design

1405 POPLAR AVE. WENATCHEE, WASHINGTON p: 509-436-8227 e: kirsten@cascadearchitectureanddesign.com



DISCLAIMER:

THESE DOCUMENTS ARE PROVIDED BY CASCADE ARCHITECTURE & DESIGN, FOR THE DESIGN INTENT OF THIS SPECIFIC PROJECT AND ONLY THIS PROJECT. THE CONTRACTOR SHALL BE RESPONSIBLE FOR ALL CONSTRUCTION . COORDINATION, METHODS AND MATERIALS THE PROJECT. THIS INCLUDES BUT IS NOT LIMITED TO THE QUALITY OF WORKMANSHIP AND MATERIALS REQUIRED FOR EXECUTION OF THESE DOCUMENTS AND WORK OR MATERIALS SUPPLIED BY ANY SUBCONTRACTORS. ALL WORK SHALL COMPLY WITH GOVERNING CODES AND ORDINANCES. THE CONTRACTOR SHALL REVIEW AND UNDERSTAND ALL DOCUMENTS AND SHALL NOTIFY THE ARCHITECT IMMEDIATELY OF ANY DISCREPANCIES IN THE DRAWINGS, FIELD CONDITIONS OR DIMENSIONS.

22.017 PROJECT NUMBER:

RES **REST** WEN 8/


ISSUED/REVISION SCHEDULE DESCRIPTION AUTHOR DATE

PERMIT

09.30.2022

SHEET NAME

FOUNDATION PLAN

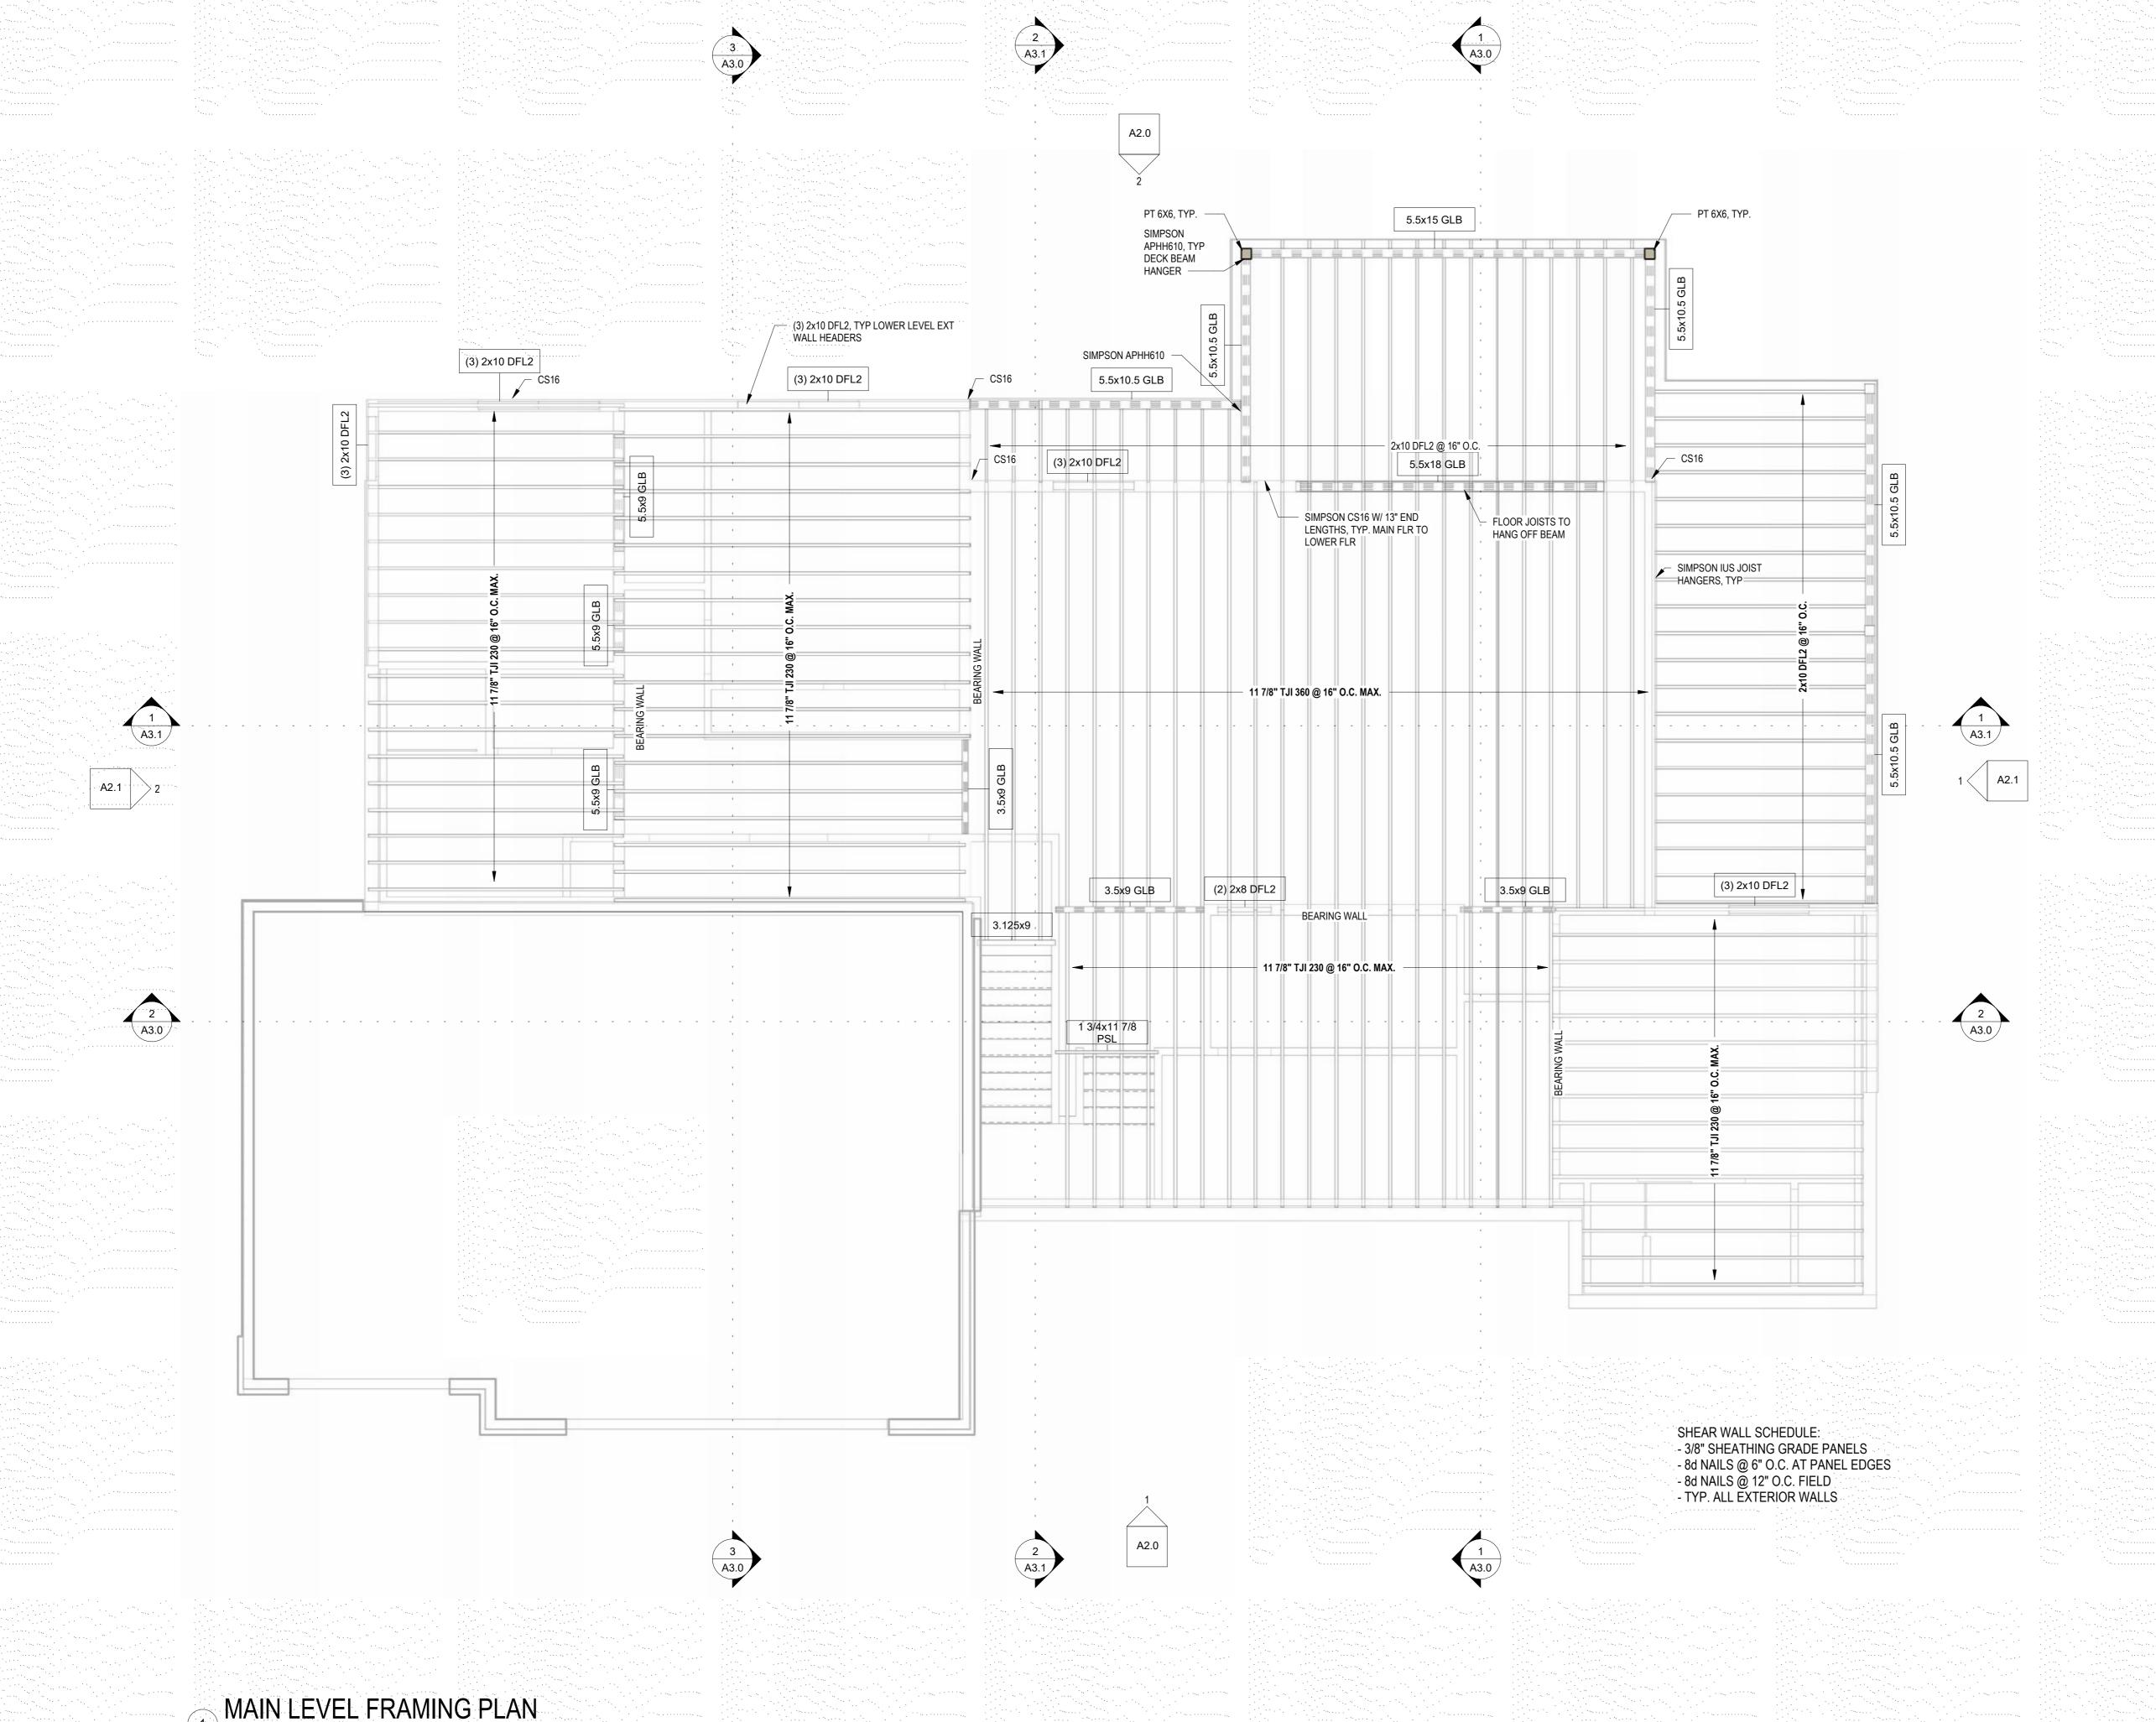

CASCADE Architecture & Design

1405 POPLAR AVE.
WENATCHEE, WASHINGTON
p: 509-436-8227
e: kirsten@cascadearchitectureanddesign.com



DISCLAIMER:

THESE DOCUMENTS ARE PROVIDED BY CASCADE ARCHITECTURE & DESIGN, FOR THE DESIGN INTENT OF THIS SPECIFIC PROJECT AND ONLY THIS PROJECT. THE CONTRACTOR SHALL BE RESPONSIBLE FOR ALL CONSTRUCTION COORDINATION, METHODS AND MATERIALS REQUIRED FOR THE SUCCESSFUL COMPLETION OF THE PROJECT. THIS INCLUDES BUT IS NOT LIMITED TO THE QUALITY OF WORKMANSHIP AND MATERIALS REQUIRED FOR EXECUTION OF THESE DOCUMENTS AND WORK OR MATERIALS SUPPLIED BY ANY SUBCONTRACTORS. ALL WORK SHALL COMPLY WITH GOVERNING CODES AND ORDINANCES. THE CONTRACTOR SHALL REVIEW AND UNDERSTAND ALL DOCUMENTS AND SHALL NOTIFY THE ARCHITECT IMMEDIATELY OF ANY DISCREPANCIES IN THE DRAWINGS, FIELD CONDITIONS OR

DIMENSIONS.

22.017

PROJECT NUMBER:

AUTUMN CREST 2.0

70 A HELLING CREST DR

ISSUED/REVISION SCHEDULE
DESCRIPTION AUTHOR DATE

PERMIT


09.30.2022 SHEET NAME

MAIN LEVEL FRAMING

PLAN

SHEET No.

S1.1

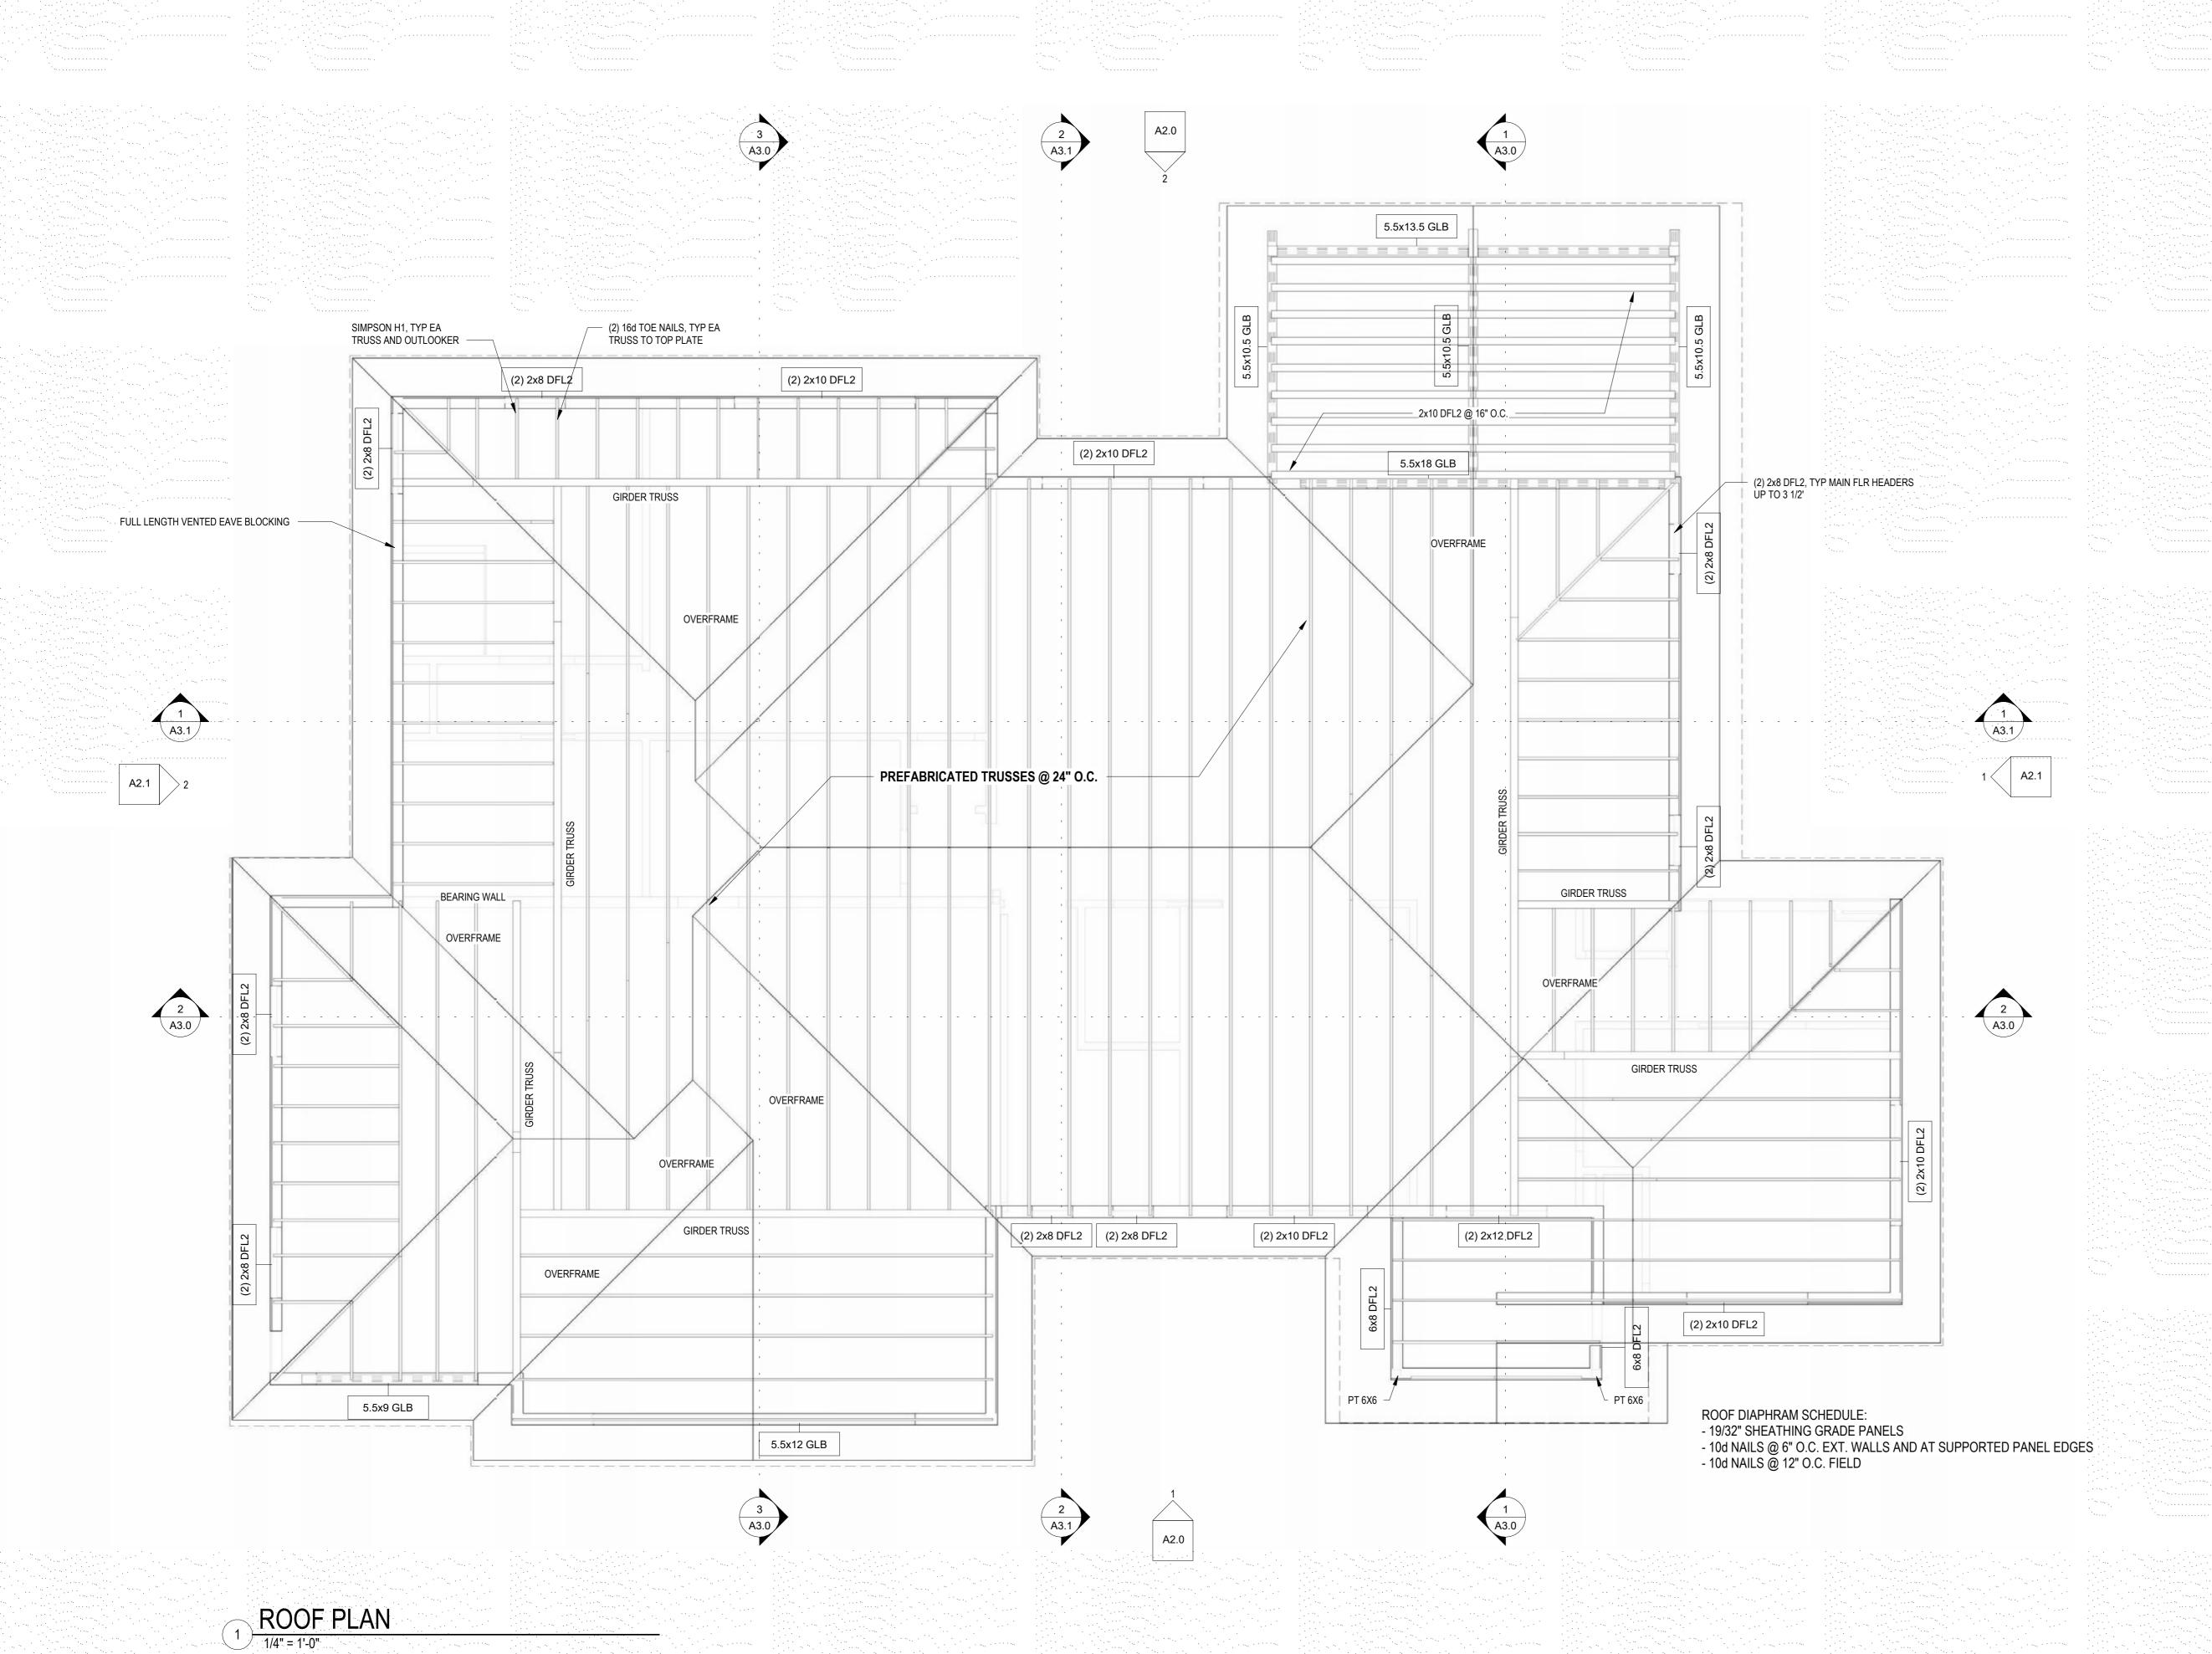

CASCADE Architecture & Design

1405 POPLAR AVE.
WENATCHEE, WASHINGTON
p: 509-436-8227
e: kirsten@cascadearchitectureanddesign.com



DISCLAIMER:

THESE DOCUMENTS ARE PROVIDED BY CASCADE
ARCHITECTURE & DESIGN, FOR THE DESIGN INTENT
OF THIS SPECIFIC PROJECT AND ONLY THIS
PROJECT. THE CONTRACTOR SHALL BE
RESPONSIBLE FOR ALL CONSTRUCTION
COORDINATION, METHODS AND MATERIALS
REQUIRED FOR THE SUCCESSFUL COMPLETION OF
THE PROJECT. THIS INCLUDES BUT IS NOT LIMITED TO
THE QUALITY OF WORKMANSHIP AND MATERIALS
REQUIRED FOR EXECUTION OF THESE DOCUMENTS
AND WORK OR MATERIALS SUPPLIED BY ANY
SUBCONTRACTORS. ALL WORK SHALL COMPLY
WITH GOVERNING CODES AND ORDINANCES. THE
CONTRACTOR SHALL REVIEW AND UNDERSTAND
ALL DOCUMENTS AND SHALL NOTIFY THE
ARCHITECT IMMEDIATELY OF ANY DISCREPANCIES
IN THE DRAWINGS, FIELD CONDITIONS OR

PROJECT NUMBER: 22.017

DIMENSIONS.

870 AUTUMN CREST DR. WENATCHEE, WA 98801

ISSUED/REVISION SCHEDULE
DESCRIPTION AUTHOR DATE


PERMIT 09.30.2022

SHEET NAME

ROOF FRAMING PLAN

SHEET No.

\$1.2

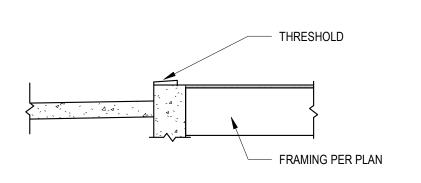

GARAGE DOOR THRESHOLD 1/2" = 1'-0"

FTG. TO BEAR ON FIRM

UNDISURBED SOIL

2X PLATE MUD SILL


INT. THICKENED SLAB

#4 @ 24" O.C EACH WAY OR


FIBER REINFORCEMENT.

2500 PSI CONCRETE

#4 BAR CONT.

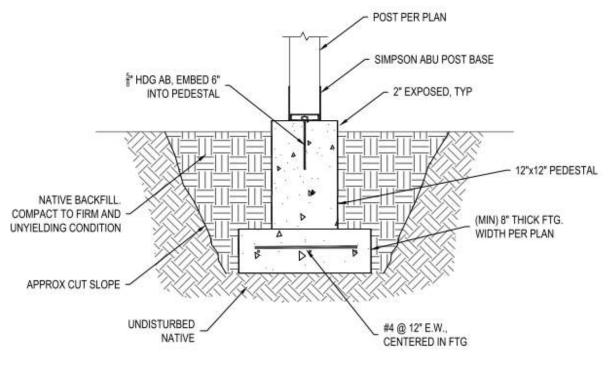


POST FOOTING

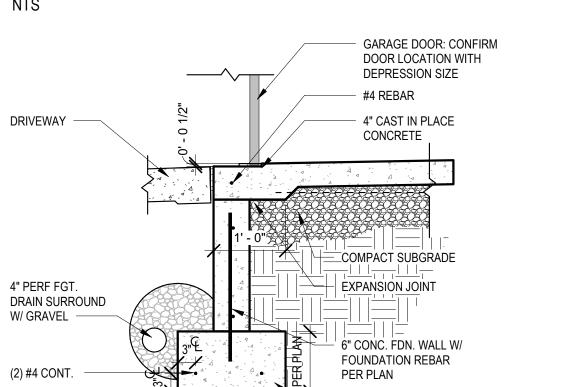



EXT. FOUNDATION @ GARAGE DOOR

3/4" = 1'-0"

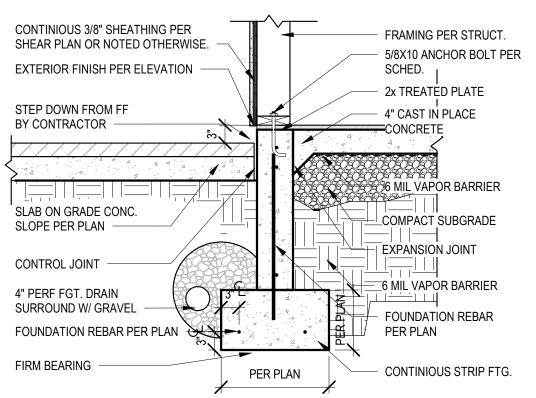


EXT. FOUNDATION WALL @ PATIO 2 3/4" = 1'-0"

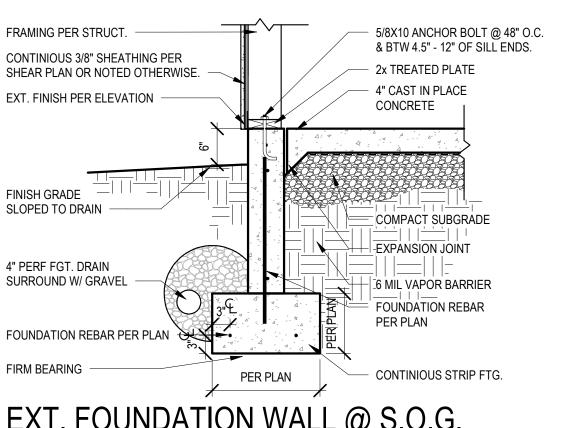

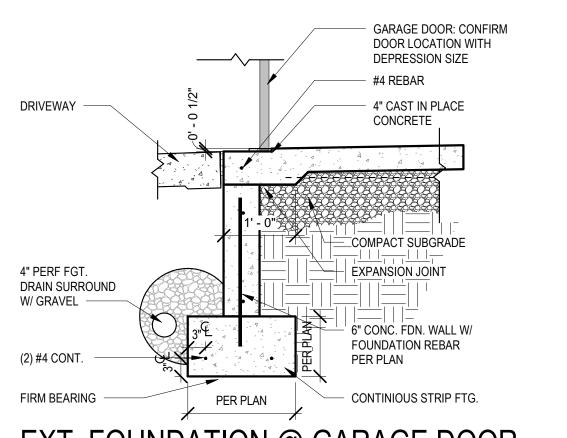

3/4" = 1'-0"

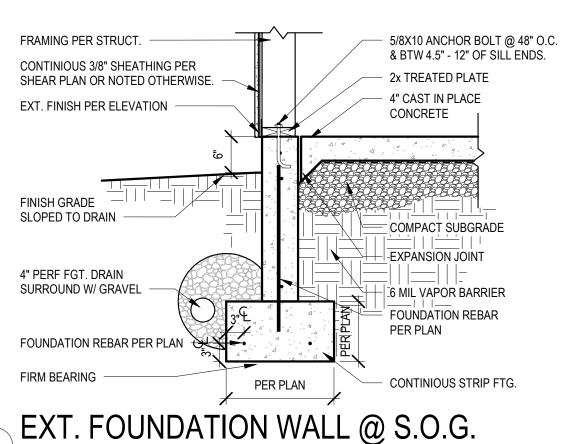

2X PLATE MUD SILL W/A.B.s IN

74" CONC. SLAB OVER CLEAN

- 4" CONC. SLAB OVER CLEAN


FTG. TO BEAR ON FIRM


UNDISURBED SOIL

SAND AND GRAVEL OVER 6 ML.


SAND AND GRAVEL OVER 6 ML.

SHEAR LOCATIONS

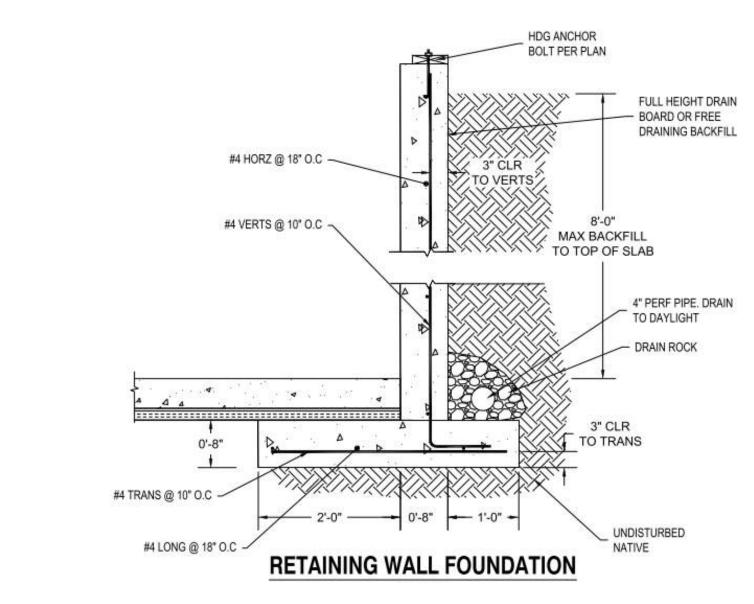

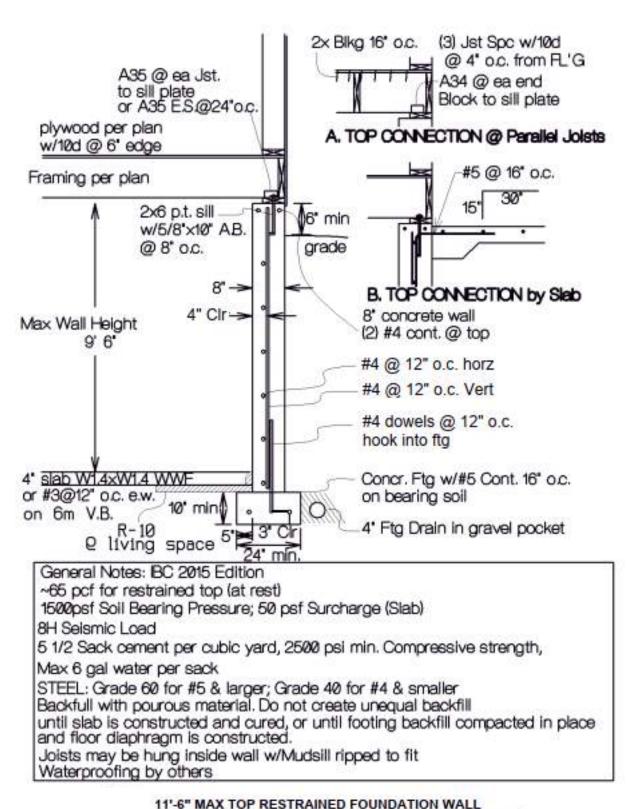

BASEMENT FOUNDATION WALL

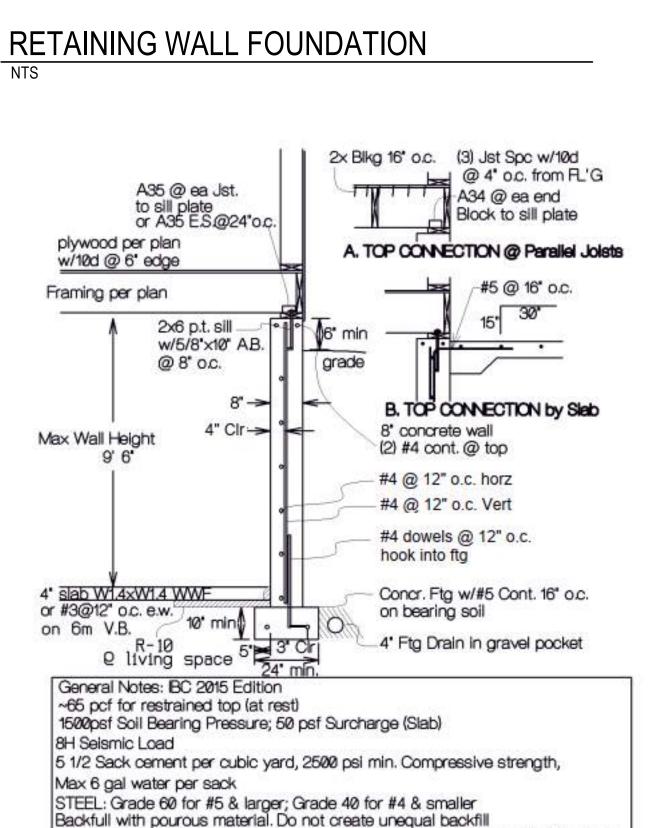

TOP FLANGE JOIST HANGER SIMPSON OR EQUIVALENT 2x6 BASE PL. W/ 16d @ 16" O.C. TO JST & 2-16d EA STUD 3/4" APA T&G OSB OR PLYWD. 2x6 PRESS. TRTD. SILL PLATE W/ CD INT. W/ EXT. GLUE. NAIL W/ 1/2" A.B. @ 48" O.C. OR PER 10d @ 6" O.C. EDGES & SOLID PLAN & BTWN. 41/2" & 12" OF BLKG. & @ 10" O.C. IN FIELD SILL ENDS, EMBED 7" MIN. INSTALL 3x3x1/4' PLATE WASHERS. FLOOR JOISTS PER PLAN FINISHED GRADE SLOPED FOR 6" MIN. FALL WITHIN 10' OR PROVIDE SWALE OR DRAIN. INSUL. PLUMBING & MECH. SEE PLAIN CONC. FND. DETAIL ON THIS SHEET INTERIOR GRADE - ROOF DRAIN 4" TIGHTLINE SEP FROM FTG DRAIN 4"Ø PERF PIPE IN 18" MIN. CRAWL SPACE WASHED GRAVEL. 12" MIN. UNDER BEAMS CONNECT TO APPROVED 6 MIL BLACK POLY BARRIER 1'-0" ONE STORY
1'-3" TWO STORY LAP SEAMS 12" MINIMUM JOISTS SECTION HANGING SCALE: 3/8" = 1'-0" WHERE APPLICABLE

SLAB EDGE @ SIDEWALK AND PATIO

BASEMENT FOUNDATION WALL 2

SIMPSON ITS HANGER, MIN G90 GALVANZIED, TYP SHEAR WALL ABOVE (2) LAYERS 40# BLDG PAPER BETWEEN BLK & -PT SILL PLATE CONCRETE, TYP HDG ANCHOR BOLT PER PLAN #4 HORZ @ 16" O.C, FLOOR SHTG CENTERED IN STEM WALL PER PLAN - 6" STEM WALL FLOOR JOISTS PER PLAN (MIN) 8" THICK FTG. WIDTH PER PLAN

#4 VERTS @ 12" O.C.,


E.W., ALT HOOKS

(3) #4 HORZ


CENTERED IN FTG

FLOOR JOIST AT FOUNDATION WALL 2

UNDISTURBED .

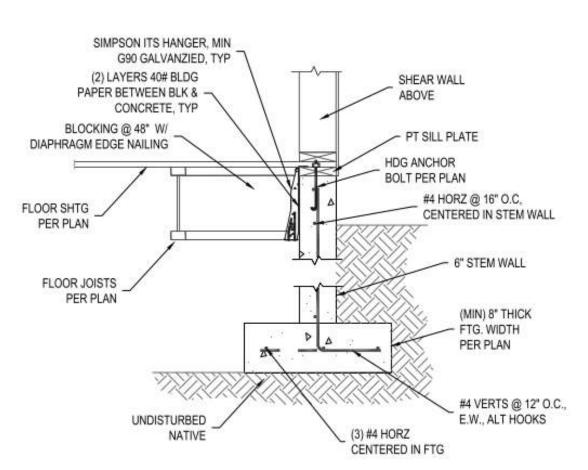

FLOOR JOIST AT FOUNDATION WALL

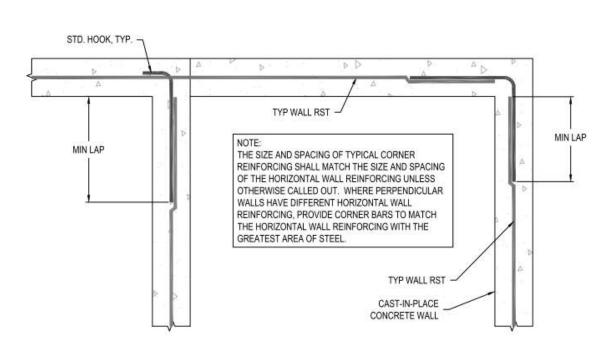

CONCRETE WALL INTERSECTION

CASCADE Architecture & Design

1405 POPLAR AVE. WENATCHEE, WASHINGTON p: 509-436-8227 e: kirsten@cascadearchitectureanddesign.com



DISCLAIMER:
THESE DOCUMENTS ARE PROVIDED BY CASCADE ARCHITECTURE & DESIGN, FOR THE DESIGN INTENT OF THIS SPECIFIC PROJECT AND ONLY THIS PROJECT. THE CONTRACTOR SHALL BE RESPONSIBLE FOR ALL CONSTRUCTION REQUIRED FOR THE SUCCESSFUL COMPLETION OF THE PROJECT. THIS INCLUDES BUT IS NOT LIMITED TO THE QUALITY OF WORKMANSHIP AND MATERIALS AND WORK OR MATERIALS SUPPLIED BY ANY SUBCONTRACTORS. ALL WORK SHALL COMPLY WITH GOVERNING CODES AND ORDINANCES. THI CONTRACTOR SHALL REVIEW AND UNDERSTAND ALL DOCUMENTS AND SHALL NOTIFY THE ARCHITECT IMMEDIATELY OF ANY DISCREPANCIES IN THE DRAWINGS, FIELD CONDITIONS OR

DIMENSIONS.

22.017

880

工

WEN,

0

 ∞

PROJECT NUMBER:

2 Ш́ **8** Zψ Ш


ISSUED/REVISION SCHEDULE DESCRIPTION AUTHOR DATE

> PERMIT 10.03.2022

SHEET NAME

DETAILS

SHEET No. \$5.0

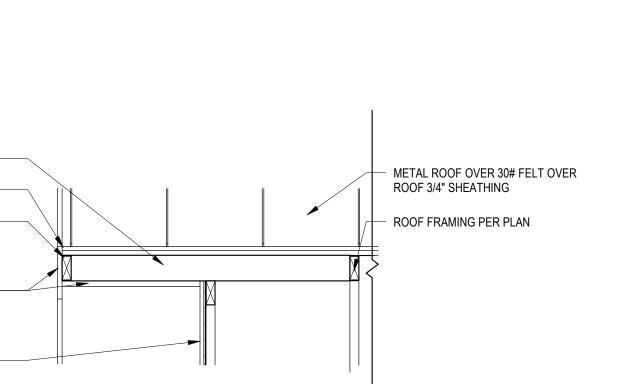

TYP. RAKE EAVE DETAIL 3/4" = 1'-0"

2X LADDER FRAMING


METAL FLASHING


2X SUBFASCIA

FIBER CEMENT SOFFIT AND FASCIA


FIBER CEMENT SIDING OVER 7/16" OSB SHEATHING OVER


2X6 FRAMING WITH WALL R VALUE - 20 OR 13+5 -

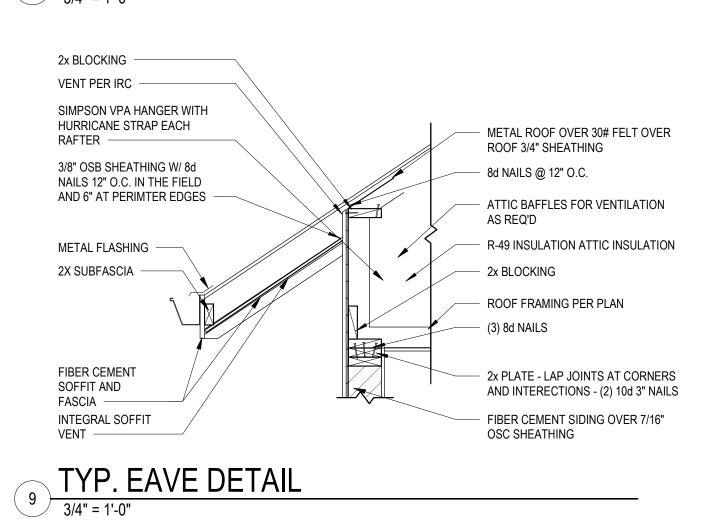

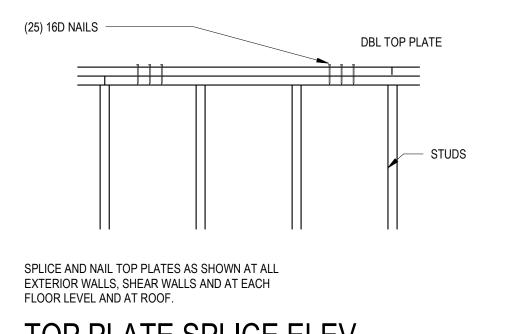


TOP PLATE SPLICE ELEV.

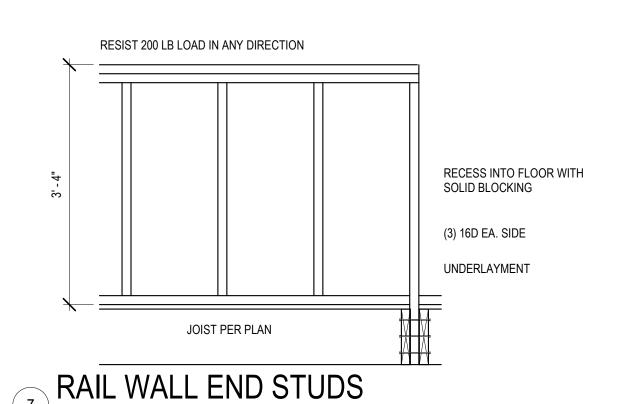

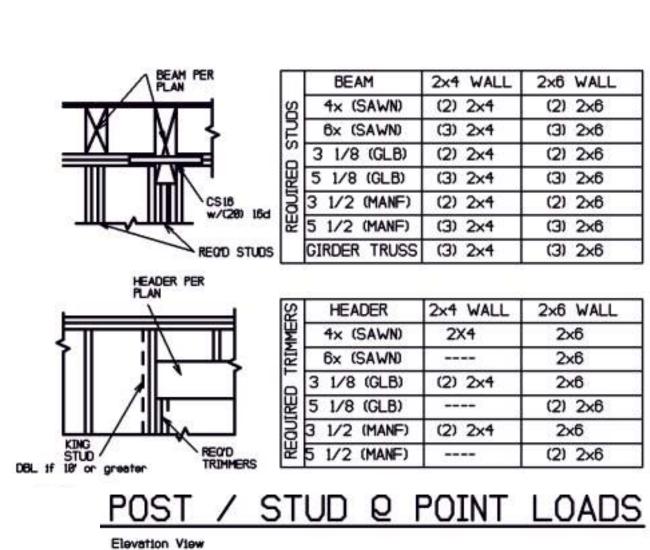



POST/STUDS @ POST LOADS

1/2" = 1'-0"

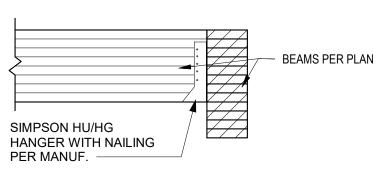


BEAM TO BEAM DETAIL

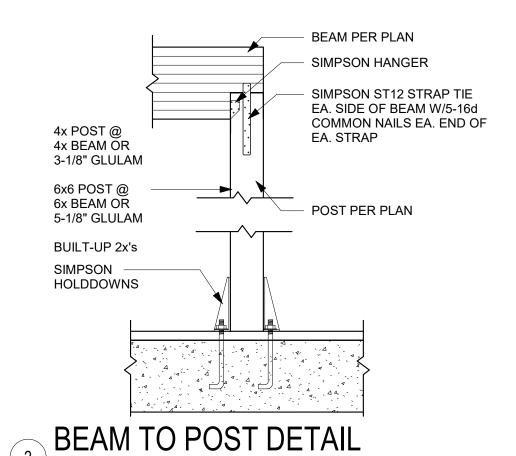


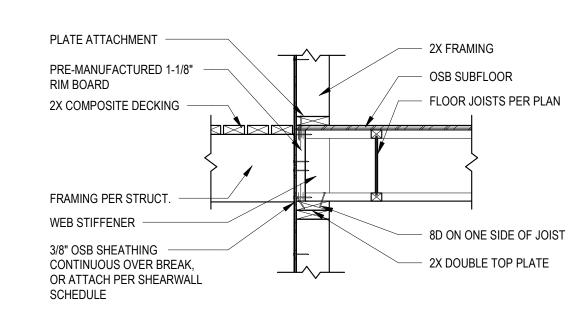

FLOOR FRAMING @ DECK 3/4" = 1'-0"

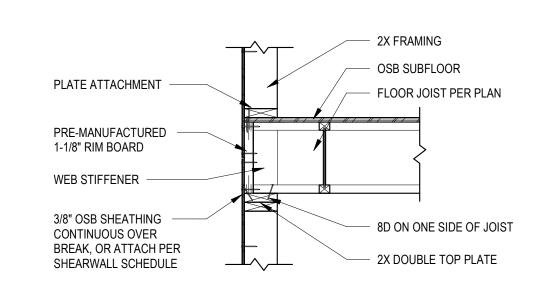


FLOOR FRAMING @ RIM JOIST 3/4" = 1'-0"

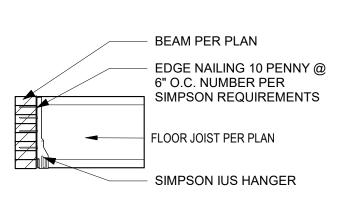

FLOOR JOIST TO BEAM

Architecture & Design

1405 POPLAR AVE. WENATCHEE, WASHINGTON p: 509-436-8227 e: kirsten@cascadearchitectureanddesign.com

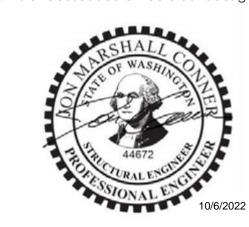

DISCLAIMER: THESE DOCUMENTS ARE PROVIDED BY CASCADE ARCHITECTURE & DESIGN, FOR THE DESIGN INTENT OF THIS SPECIFIC PROJECT AND ONLY THIS PROJECT. THE CONTRACTOR SHALL BE RESPONSIBLE FOR ALL CONSTRUCTION COORDINATION, METHODS AND MATERIALS REQUIRED FOR THE SUCCESSFUL COMPLETION OF THE PROJECT. THIS INCLUDES BUT IS NOT LIMITED TO THE QUALITY OF WORKMANSHIP AND MATERIALS REQUIRED FOR EXECUTION OF THESE DOCUMENTS AND WORK OR MATERIALS SUPPLIED BY ANY SUBCONTRACTORS. ALL WORK SHALL COMPLY WITH GOVERNING CODES AND ORDINANCES. THE CONTRACTOR SHALL REVIEW AND UNDERSTAND ALL DOCUMENTS AND SHALL NOTIFY THE ARCHITECT IMMEDIATELY OF ANY DISCREPANCIES IN THE DRAWINGS, FIELD CONDITIONS OR

DIMENSIONS.

22.017

80

PROJECT NUMBER:

ES | REST JMN HEE, 870 AUTU WENATC

ISSUED/REVISION SCHEDULE DESCRIPTION AUTHOR DATE

> PERMIT 10.03.2022

SHEET NAME

DETAILS

SHEET No.

\$5.1